# MIAMI INTERNATIONAL AIRPORT

SOUTH TERMINAL CONCOURSE H REHABILITATION - PHASE 1

CONTRACT NO. AA018B 21 MIAD CIRCLE MIAMI, FLORIDA 33126



### **MIAMI-DADE COUNTY**

Daniella Levine Cava

Mayor

## **BOARD OF COUNTY COMMISSIONERS**

Oliver G. Gilbert, III

Vice Chairman

Chairman

**Anthony Rodriguez** 

Oliver G. Gilbert, III

Danielle Cohen Higgins

District 8

Marleine Bastien

**Kionne L. McGhee** *District* 9

District 2

District 1

**Anthony Rodriguez** 

**Keon Hardemon** *District 3* 

District 10

Micky Steinberg

Roberto J. Gonzalez

District 4

District 11

**Eileen Higgins** 

Juan Carlos Bermudez

District 12

District 5

Daná Caral

**Kevin M. Cabrera** *District 6* 

René Garcia
District 13

Raquel A. Regalado

District 7

Juan Fernandez-Barquin

Clerk of Courts

Geri Bonzon-Keenan

County Attorney

Project Managed By:

# Miami Dade Aviation Department Facilities Management and Engineering Division

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Ralph Cutié

Aviation Director & Chief Executive Officer

Ken Pyatt

Aviation Deputy Director

Isaac Smith

Assistant Director, Facilities Management and Engineering





BL + A
ARCHITECTS

ENRIQUE M. ZÚÑIGA FLORIDA, P.E. No. 38883

AIA South Terminal Concourse F Rehabilitation - Phase 1 21 MIAD CIRCLE MIAMI, FLORIDA 33126

2 5/6/2022 CNZ BLDG. DEPT. COMMENTS
1 3/8/2022 CNZ BLDG. DEPT. COMMENTS
NO. DATE BY DESCRIPTION
REVISIONS

DATE:
FEBRUARY 4, 2022

SCALE:
AS SHOWN

DESIGN BY:
E.M.Z.

DRAWN BY:
C.N.Z.

REVIEWED BY:
E.M.Z.

PROJECT NO.:
18-0305.02

DRAWING TITLE:

COVER SHEET

DRAWING NO.:

PLOT DATE: 11/8/2023 | Projects\18 - 0305.02 - MIA Glazing Concourse H\1-AC

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SHEET NO.: 1 OF 42

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OJECT MANAGER:

ENRIQUE M. ZÚÑIGA

305 CONSULTING ENGINEERS LLC

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BEN LOPEZ & ASSOCIATES, PA (BL & A ARCHITECTS) 340 MINORCA AVENUE, SUITE 9 CORAL GABLES, FL 33134 PHONE: (305) 445-1030 BEN LOPEZ, P.A. FL LICENSE NO. AR00055776




H.RODRIGUEZ CONSULTING ENGINEERING, INC. 7791 NW 46 STREET, SUITE 408 DORAL, FL 33166 PHONE: (305) 450-9555 HECTOR RODRIGUEZ, P.E. FL LICENSE NO. 30729 FL CA NO. 68362



PROJECT LOCATION

**AERIAL MAP** SCALE: N.T.S



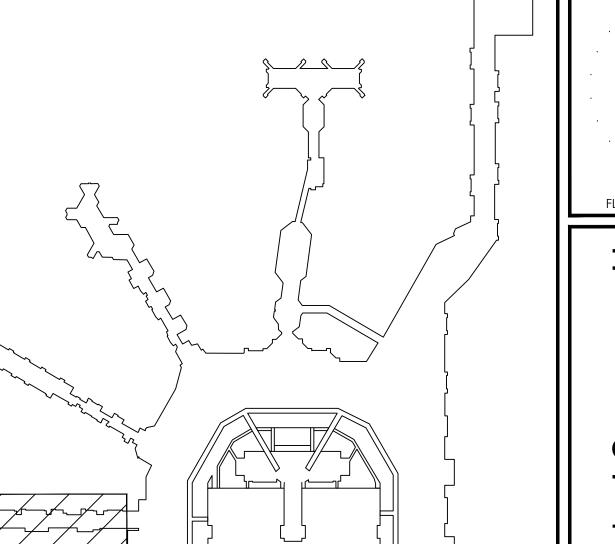

AREA OF WORK



SITE PLAN

FEBRUARY 4, 2022 SCALE: AS SHOWN

DESIGN BY:

18-0305.02 DRAWING TITLE:

G0.02

SCOPE OF WORK

DIRECTORY

SCALE: N.T.S

1. REMOVE AND REPLACE THE FAILED WINDOW WALL STRUCTURES DOWN TO THE EXISTING STRUCTURE AND REPLACE WITH THE SAFTIFIRST GPX ONE HOUR FIRE RATED WINDOW WALL STRUCTURE AND REPLACE WITH THE SALTHINGS SEA SILE INTO SYSTEM (L.M.I.) OR APPROVED EQUAL. GATES H4, H6-H8, AND H10.

- 2. REMOVE AND REPLACE THE FAILED WINDOW WALL DOWN TO THE EXISTING STRUCTURE AND REPLACE WITH FAOUR GLASS TECHNOLOGIES SERIES 'SLIMPACT XL' IMPACT RATED WINDOW WALL SYSTEM (L.M.I.) OR APPROVED EQUAL. GATE H3.
- 3. REMOVE THE SEALANTS AROUND THE GLAZING SYSTEM AND REINSTALL NEW SEALANTS. IT SHOULD BE NOTED THAT SEALANT MAINTENANCE IS REQUIRED AT 5-YEAR INTERVALS IN ACCORDANCE WITH THE REQUIREMENTS OF THE FLORIDA BUILDING CODE SECTION 2415 TO INSURE A WATERTIGHT ASSEMBLY.
- 4. REPAIR PARTS OF THE METAL STRUCTURAL ELEMENTS THAT MAY HAVE CORRODED. STEEL ELEMENTS THAT HAVE LOST MORE THAN 10% OF ITS CROSS-SECTIONAL AREA WILL BE REINFORCED WITH ADDITION OF FLAT PLATES AND/OR ANGLES WELDED TO RESTORE THE STRUCTURAL INTEGRITY OF THE MEMBER. THE MEMBERS TO BE REPAIRED SHALL BE WIRE BRUSHED TO REMOVE SURFACE RUST AND FLAKING MATERIAL AND PAINTED WITH A RUST INHIBITIVE PRIMER.
- 5. CONSTRUCTION SHALL CONFORM TO THE 1998 LIFE SAFETY MASTER PLAN FOR THE TERMINAL COMPLEX. EXISTING PORTIONS OF BUILDINGS SHALL COMPLY WITH THE PROVISIONS OF EXISTING OCCUPANCIES AS SET FORTH IN THE FLORIDA FIRE PREVENTION CODE.
- 6. GLAZING IN WINDOWS SHALL BE CATEGORY II SAFETY GLAZING FBC 2406.4.3, WHEN EXPOSED GLAZED AREA IS LARGER THAN 36" A.F.F., WHEN THERE IS A WALKING SURFACE WITHIN 36" HORIZONTALLY OF GLAZING.
- 7. FOR IMPAIRMENT OF SYSTEMS REFER TO NFPA 72:142.2.2; NFPA 13:26.1; NFPA 1:13.3.4; NFPA 25: CH 15.

DRAWING INDEX

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ENRIQUE M. ZÚÑIGA FLORIDA, P.E. No. 38883

26 South. Behabilite 21 M MIAMI, F

DRAWN BY: REVIEWED BY: E.M.Z. PROJECT NO.:

INDEX & PROJECT INFORMATION DRAWING NO .:

SHEET NO.: 2 OF 42

CONSTRUCTION CONSTRUCTION DRAWINGS

**ADDENDA** MODIFICATIONS

DEFINITIONS:

- ACCEPTED: AS ACCEPTED BY THE DESIGN PROFESSIONAL. <u>ACCEPTED EQUAL:</u> AS ACCEPTED BY THE DESIGN PROFESSIONAL AS BEING OF EQUIVALENT QUALITY,
- UTILITY, AND APPEARANCE. AS APPLICABLE: AS APPROPRIATE FOR THE PARTICULAR CONDITION CIRCUMSTANCE, OR SITUATION.
- AS REQUIRED: AS REQUIRED BY REGULATORY REQUIREMENTS, BY REFERENCED STANDARDS, BY EXISTING CONDITIONS. BY GENERALLY ACCEPTED CONSTRUCTION PRACTICE, OR BY THE CONTRACT DOCUMENTS. DESIGN PROFESSIONAL: ENGINEER OF RECORD (E.O.R.)
- AND ARCHITECT OF RECORD (A.O.R.) DIRECTED: AS INSTRUCTED BY THE DESIGN PROFESSIONAL
- IN WRITING. SATISFACTORY: TO THE SATISFACTION OF THE DESIGN PROFESSIONAL, SUBJECT TO THE DESIGN PROFESSIONAL'S
- ACCEPTANCE. TYPICAL: IDENTICAL FOR ALL SUCH CONDITIONS, UNLESS
- DTHERWISE INDICATED. SIMILAR: COMPARABLE CHARACTERISTICS FOR THE CONDITION NOTED. DIFFERENCES CAN BE INFERRED FROM OTHER INFORMATION INDICATED. VERIFY DIMENSIONS AND ORIENTATIONS.
- FURNISH: SUPPLY ONLY AND OTHERS WILL INSTALL. INSTALL: INSTALL ITEMS FURNISHED BY OTHERS. PROVIDE: FURNISH AND INSTALL
- ALL WORK TO BE PERFORMED SHALL COMPLY WITH THE REQUIREMENTS OF THE FLORIDA BUILDING CODE (F.B.C.) 7TH EDITION (2020) AND MIAMI DADE COUNTY ZONING ORDINANCES REGULATIONS AND ANY AGENCY HAVING JURISDICTION ON THIS
- MATERIALS AND / OR CONSTRUCTION SYSTEMS USED AS PART OF OR FOR THE PROTECTION OF THE ENVELOPE OF THE STRUCTURE, INCLUDING BUT NOT LIMITED TO WINDOWS, EXTERIOR GLAZING, WALL CLADDING, ROOFING, EXTERIOR DOORS, SKYLIGHTS, GLASS BLOCK, SIDING, AND SHUTTERS MUST HAVE PRODUCT CONTROL ACCEPTANCE NUMBERS IN COMPLIANCE WITH THE REQUIREMENTS OF MIAMI DADE COUNTY BUILDING CODE COMPLIANCE DEPARTMENT.
- THE WORK SHALL INCLUDE THE FURNISHING OF ALL LABOR, MATERIALS, EQUIPMENT, TRANSPORTATION AND SERVICES NECESSARY TO DO A COMPLETE AND THOROUGH JOB. ALL WORK SHALL BE DONE IN ACCORDANCE TO THE DRAWINGS.
- WORK NOT INCLUDED IN CONTRACT: WORK NOTED "N.I.C." OR BY OTHERS ON THE DRAWINGS OR SPECIFICATIONS, IF ANY MATERIALS, EQUIPMENT OR BOTH, INDICATED "N.I.C." ARE TO BE INSTALLED BY THE CONTRACTOR, THEY WILL BE SO NOTED ON THE DRAWINGS OR SPECIFICATIONS.
- ALL OMISSIONS OR CONFLICTS BETWEEN THE VARIOUS ELEMENTS OF THE WORKING DRAWINGS, SHALL BE BROUGHT TO THE IMMEDIATE ATTENTION OF THE ENGINEER, BEFORE PROCEEDING WITH ANY WORK SO INVOLVED. ANY WORK INSTALLED IN CONFLICT WITH THE DRAWINGS SHALL BE CORRECTED BY THE CONTRACTOR AT HIS/HER OWN EXPENSE, AND NOT AT EXPENSE OF THE OWNER OR ENGINEER.
- CONTRACTOR SHALL VERIFY AND BE RESPONSIBLE FOR ALL DIMENSIONS AND CONDITIONS OF THE JOB. THE DESIGN PROFESSIONAL SHOULD BE NOTIFIED BEFORE PROCEEDING WITH THE WORK OF ANY DISCREPANCIES IN THE CONTRACT DOCUMENTS AND CONDITIONS ON THESE DRAWINGS AND / OR ALL OBVIOUS ERRORS AND OMISSIONS.
- CONTRACTOR SHALL PROMPTLY NOTIFY THE DESIGN PROFESSIONAL OF THE EXISTENCE OF ANY OBSERVED VARIATIONS BETWEEN THE CONTRACT DOCUMENTS AND ANY APPLICABLE CODE OR ORDINANCES.
- 10. FACILITIES SHALL COMPLY WITH THE FLORIDA ACCESSIBILITY CODE FOR BUILDING CONSTRUCTION AND THE AMERICAN WITH DISABILITIES ACT, PUBLIC LAW 101-336 (A.D.A.) WHICHEVER MORE STRINGENT
- CONTRACTOR SHALL VERIFY ALL DIMENSIONS AND TOPOGRAPHIC SPOT ELEVATIONS AND NOTIFY THE ENGINEER OF ANY EXISTING DISCREPANCIES PRIOR TO PROCEEDING WITH
- CONTRACTOR ACKNOWLEDGES THAT HE HAS FULLY INFORMED HIMSELF / HERSELF. REGARDING REQUIREMENTS OF DRAWINGS, SPECIFICATIONS AND REGULATIONS PERTAINING TO THE PROJECT. SPECIFICATIONS AND DRAWINGS ARE COMPLEMENTARY, AND WHAT IS CALLED FOR BY ONE IS AS BINDING AS IF CALLED FOR BY ALL. VISIT SITE OF WORK. COMPARE REQUIREMENTS OF DRAWINGS AND SPECIFICATIONS AND BECOME FAMILIAR WITH EXISTING CONDITIONS UNDER WHICH WORK OF CONTRACT IS TO BE PERFORMED INCLUDING TOPOGRAPHY, APPROACHES AND IMPROVEMENTS ON OR ABOUT SITE. PROTECTION OF ADJACENT BUILDINGS AND PROPERTY.
- EXERCISE ALL REQUIRED PRECAUTIONS NECESSARY TO PROTECT ALL BUILDINGS AND OTHER CONSTRUCTIONS ON PROPERTY ADJACENT TO THAT OF THE WORK OF THIS CONTRACT. CONTRACTOR SHALL BE RESPONSIBLE FOR, AND PAY FOR ALL DAMAGES TO SUCH ADJACENT BUILDINGS AND CONSTRUCTION ON ACCOUNT OF OPERATIONS UNDER THE CONTRACT.
- THE DESIGN PROFESSIONAL SHALL NOT HAVE CONTROL OR CHARGE OF, AND SHALL NOT BE RESPONSIBLE FOR THE MEANS, METHODS, TECHNIQUES, SEQUENCES OR PROCEDURES OF CONSTRUCTION, FABRICATION, PROCUREMENT, SHIPMENT, DELIVERY OR INSTALLATION OR FOR SAFETY PRECAUTIONS AND PROGRAMS IN CONNECTION TO THE WORK FOR THE ACTS OR OMISSIONS OF THE CONTRACTOR, SUBCONTRACTORS, SUPPLIERS. OR ANY OTHER PERSONS PERFORMING ANY OF THE WORK OR FOR THE FAILURE OF ANY OF THEM TO CARRY OUT THE WORK OR TO MEET THEIR SCHEDULES FOR DELIVERY OR COMPLETION IN ACCORDANCE TO THE CONTRACT DOCUMENTS.
- WRITTEN DIMENSIONS TAKE PRECEDENCE OVER SCALED DIMENSIONS, IF ANY DISCREPANCIES ARISE, THE DESIGN PRFESSIONAL IS TO BE NOTIFIED PRIOR TO THE COMMENCEMENT OF WORK FOR CLARIFICATION. ALL DIMENSIONS INDICATED ON THE PLANS ARE AS FOLLOWS:
- A. DIMENSIONS NOTED "CLEAR" OR "CLR" MUST BE PRECISELY MAINTAINED. THOSE NOTED "HOLD" SHALL NOT
- VARY FROM STATED DIMENSION. DIMENSIONS ARE NOT ADJUSTABLE WITHOUT ACCEPTANCE
- BY THE ENGINEER, UNLESS NOTED DIMENSIONS TO THE EXTERIOR WINDOW WALL ARE TO THE INSIDE FACE OF THE EXTERIOR WINDOW FRAMES, UNLESS OTHERWISE NOTED.

D. VERTICAL DIMENSIONS ARE FROM THE TOP OF THE FLOOR SLAB DATUM LINE, ESTABLISHED BY THE CONTRACTOR SUBJECT TO THE ACCEPTANCE OF THE OWNER OR DESIGN PROFESSIONAL, UNLESS OTHERWISE NOTED. DO NOT SCALE DRAWINGS. IF ITEMS OF THE WORK CANNOT BE LOCATED, DO NOT PROCEED WITH THE WORK

WITHOUT THE CONSENT OF THE DESIGN PROFESSIONAL.

DIMENSIONS MARKED V.I.F. SHALL BE "VERIFIED" IN FIELD

- BY THE CONTRACTOR. 17. CONTRACTOR AND ALL SUBCONTRACTORS ARE TO HOLD HARMLESS THE DESIGN PROFESSIONAL AND OWNER OF ALL LAWSUITS AND CLAIMS WHICH ARISE FROM WORK PERFORMED
- BY OR MATERIALS SUPPLIED BY THE CONTRACTORS AND THE SUBCONTRACTORS.
- 18. PROVIDE A PROJECT SECURITY PROGRAM TO PROTECT WORK, MATERIAL AND EQUIPMENT FROM THEFT AND VANDALISM. VANDALIZED WORK MATERIAL AND EQUIPMENT AT NO ADDITIONAL COST TO OWNER UNTIL COMPLETED PROJECT IS ACCEPTED BY OWNER.
- CONTRACTOR SHALL VERIFY THAT NO CONFLICTS EXIST IN LOCATIONS OF ANY AND ALL MECHANICAL, TELEPHONE, ELECTRICAL, LIGHTING AND PLUMBING (TO INCLUDE ALL PIPING DUCTWORK AND CONDUITS) AND THAT REQUIRED CLEARANCES FOR INSTALLATION AND MAINTENANCE OF ABOVE MENTIONED EQUIPMENT ARE PROVIDED.
- 20. THE CONTRACTOR IS RESPONSIBLE FOR PROTECTING ALL UNDERGROUND UTILITIES AND / OR STRUCTURES SHOWN AND ANY OTHER UTILITIES OR STRUCTURES NOT OF RECORD OR SHOWN ON THESE PLANS.
- 21. ALL LABOR INSTALLATION SHALL BE PERFORMED IN THE BEST POSSIBLE MANNER BY SKILLED AND EXPERIENCED WORKMAN TRAINED IN THEIR RESPECTIVE TRADES.
- 22. THE DESIGN PROFESSIONAL RESERVES THE RIGHT TO REJECT MATERIALS AND WORK QUALITY WHICH ARE NOT CONSIDERED TO BE UP TO THE SPECIFIED STANDARDS OF THE VARIOUS TRADES INVOLVED. SUCH INFERIOR MATERIAL OR WORK QUALITY SHALL BE REPAIRED OR REPLACED, AS DIRECTED, AT NO ADDITIONAL COST TO THE OWNER.
- 23. ALL FINISH MATERIAL SHALL BE PROTECTED AT ALL TIMES AGAINST SUBSEQUENT DAMAGE UNTIL FINAL ACCEPTANCE BY THE OWNER.
- 24. THE ABSENCE OF A DETAIL DESCRIBING A PARTICULAR METHOD OF CONSTRUCTION SHALL IMPLY, THE CONTRACTOR SHALL CONSTRUCT SAID DETAILS IN COMPLIANCE WITH INDUSTRY STANDARDS FOR THE TYPE OF CONSTRUCTION OF THE BUILDING.
- 25. DRAWINGS INDICATE GENERAL DETAILS OF CONSTRUCTION WHERE FIELD CONDITIONS ARE NOT IDENTICAL TO THE CONTRACT DOCUMENTS, BUT ARE OF SIMILAR CHARACTER TO THE DETAILS SHOWN, SIMILAR DETAILS OF CONSTRUCTION SHALL BE USED, SUBJECT TO REVIEW AND APPROVAL BY DESIGN PROFESSIONAL PRIOR TO CONSTRUCTION. WHERE CONSTRUCTION DETAILS ARE SHOWN FOR SPECIFIC LOCATIONS, THEY SHALL ALSO APPLY TO SIMILAR CONDITIONS THROUGHOUT, WHETHER SPECIFICALLY MENTIONED IN THE DRAWINGS OR NOT.
- 26. THE CONTRACTOR SHALL PROVIDE ALL NECESSARY BLOCKING, BACKING, FRAMING, HANGERS, OR OTHER SUPPORT, FOR ALL BUILDING EQUIPMENT AND ACCESSORIES SHOWN ON PLANS, REGARDLESS OF WHOM SUPPLIES SAID EQUIPMENT OR ACCESSORY, UNLESS OTHERWISE NOTED.
- 27. EVERY EXIT DOOR SHALL BE ABLE TO OPEN FROM THE INSIDE WITHOUT THE USE OF A KEY OR ANY OTHER SPECIAL KNOWLEDGE OR EFFORT. SPECIAL LOCKING DEVICES SHALL BE OF AN APPROVED TYPE.
- 28. ALL TRADES SHALL AT ALL TIMES, KEEP THE PREMISES FREE FROM ACCUMULATION OF WASTE MATERIAL OR RUBBISH CAUSED BY THEIR WORK. PROVIDE CLEAN-UP AND DISPOSE OF ALL DEBRIS, FOR A NEAT AND CLEAN JOB SITE CONDITION THROUGHOUT THE ENTIRE CONSTRUCTION PROCESS. AT THE COMPLETION OF THE WORK, LEAVE THE PAVEMENT AREA IN A BROOM CLEAN CONDITION WITH NO STAINS. ROLL OFF CONTAINERS MUST BE USED.
- 29. PREFABRICATED CONSTRUCTION ELEMENTS AND STRUCTURES SHALL BE MADE BY SHOPS WHICH HAVE CURRENT (CEO, UL, ETC.) CERTIFICATION AS APPROVED FABRICATORS FOR SUCH UNITS OR ELEMENTS. THE RESPONSIBLE DESIGN ENGINEER SHALL PROVIDE (A SHOP STAMP) AND APPROVE OF THE DESIGN, PLANS, CONSTRUCTION DETAILS AND SPECIFICATIONS FOR ALL PREFABRICATED FRAMING MEMBERS AND SHALL SUBMIT SAME TO THE CORRESPONDENT BUILDING AND PLANING DEPARTMENT AND RECEIVE APPROVAL THEREFROM PRIOR TO THE ERECTION OF THE MEMBERS.
- 30. THE CONTRACTOR IS TO PROVIDE SECURITY BARRIERS AND OTHER APPLICABLE DEVICES AS REQUIRED BY THE CONTRACT DOCUMENTS AND / OR LOCAL AND STATE CODE AND REGULATIONS. PLACEMENT OF SAFETY DEVICES IS TO TAKE PLACE IN A MANNER SO AS NOT TO DISRUPT THE FACILITY OPERATIONS.
- 31. REMOVED EQUIPMENT AND MATERIALS NOT BEING REUSED OR RETURNED TO OWNER SHALL BE REMOVED FROM THE SITE AND LEGALLY DISPOSED OF BY THE CONTRACTOR.
- 32. THE CONTRACTOR SHALL BE IN CHARGE OF THIS CONTRACT WITHIN THE LIMITS OF THE SITE, AND SHALL DIRECT AND SCHEDULE THE WORK. FINAL RESPONSIBILITY FOR PERFORMANCE, CODE COMPLIANCE, INTERFACE, AND COMPLETION OF THE WORK AND THE PROJECT SHALL BE THE CONTRACTOR'S.
- 33. PERFORM CUTTING AND PATCHING AS REQUIRED TO CONSTRUCT AND COMPLETE WORK OF THIS PROJECT. CUTTING OF STRUCTURAL MEMBERS REQUIRES PRIOR APPROVAL OF THE STRUCTURAL ENGINEER.
- WHEREVER THE ABBREVIATION OR ACRONYM IS SPECIFIED, IT SHALL BE UNDERSTOOD TO MEAN THE FULL NAME OF THE RESPECTIVE ORGANIZATION, AS FOLLOWS: AIA: AMERICAN INSTITUTE OF ARCHITECTS ANSI: AMERICAN NATIONAL STANDARDS INSTITUE
- ASTM: AMERICAN SOCIETY FOR TESTING & MATERIALS ARCHITECTURAL WOODWORK INSTITUTE INTERNATIONAL CODE CONFERENCE
- IBC: INTERNATIONAL BUILDING CODE IMC: INTERNATIONAL MECHANICAL CODE INTERNATIONAL PLUMBING CODE NEC: NATIONAL ELECTRICAL CODE NFPA: NATIONAL FIRE PROTECTION AGENCY
- 35. ITEMS OF EQUIPMENT, FIXTURES, AND MATERIALS NOT DEFINITELY SPECIFIED HEREIN, BUT NECESSARY FOR COMPLETION OF THE WORK, SHALL BE PROVIDED AS INDICATED ON THE DRAWINGS. SUCH ITEMS SHALL BE OF TYPE AND QUALITY SUITABLE FOR THE SERVICE REQUIRED AND COMPARABLE TO ADJACENT OR SIMILAR ITEMS IN THE

- 36. WHERE SIZE, CAPACITY, MODEL, STYLE, OR OTHER PERTINENT INFORMATION IS NOT INDICATED ON THE DRAWINGS, FURNISH EQUIPMENT, FIXTURES, OR MATERIALS OF SIZE, QUALITY, AND UTILITY WHICH WILL ADEQUATELY SERVICE THE VARIOUS BUILDING FACILITIES AS REQUIRED. WHERE THESE ARE VISIBLE IN THE FINAL WORK, OBTAIN ENGINEER'S APPROVAL BEFORE PROCEEDING.
- 37. ALL CONSTRUCTION EQUIPMENT SHALL BE MAINTAINED AND OPERATED ACCORDING TO MANUFACTURER MAINTENANCE SCHEDULES AND RECOMMENDATIONS. MINIMIZE NOISE AND EXHAUST EMISSIONS (PARTICULARLY CARBON AND NITROGEN OXIDES).
- 38. CONTRACTOR SHALL VERIFY ALL ROUGH OPENINGS FOR WINDOWS AND DOORS PRIOR TO ORDERING PRODUCTS TO ENSURE PROPER SIZE AND FIT.
- CONTRACTOR IS RESPONSIBLE FOR REPLACING ANY STOLEN OR 39. REFER TO INDIVIDUAL DRAWING SHEETS FOR ADDITIONAL NOTES.
  - 40. CONTRACTOR TO FOLLOW MDAD QUALITY ASSURANCE MANUAL.
  - 41. PATCH, REPAIR, FINISH ALL AREAS DAMAGED DURING CONSTRUCTION TO A MATCHING FINISHED APPEARANCE.
  - 42. FIELD VERIFY AREA OF WORK, DIMENSIONS, PRIOR TO SUBMITTING BID.
  - 43. CONTRACTOR TO PROVIDE PROTECTION TO EXISTING EQUIPMENT/FURNITURE, DOORS, FINISHES, ETC. AS NECESSARY.
  - 44. THE CONTRACTOR SHALL VISIT THE SITE AND VERIFY ALL EXISTING BUILDING AND SITE CONDITIONS PRIOR TO SUBMITTING HIS PROPOSAL FOR THE WORK. SHOULD ANY APPARENT ERRORS, OMISSIONS OR DISCREPANCIES BE ENCOUNTERED. THE ARCHITECT / ENGINEER SHOULD BE NOTIFIED IN WRITING 7 DAYS PRIOR TO SUBMITTING HIS BID.
  - 45. THE CONTRACTOR SHALL OBTAIN ALL REQUIRED PERMITS FOR THE CONSTRUCTION AND OCCUPANCY OF THE PROJECT.
  - 46. THE CONTRACTOR SHALL PROVIDE ALL THE SUPPLEMENTARY MATERIALS REQUIRED TO PROPERLY INSTALL, SUPPORT, BRACE AND SHORE ALL BUILDING COMPONENTS WITHIN THE SCOPE OF THE PROJECT.
  - 47. THE CONTRACTOR SHALL REPAIR AND PAINT EXISTING SURFACES DAMAGED BY DEMOLITION COVERED WITHIN THE CONTRACT DOCUMENTS TO MATCH EXISTING.
  - 48. THE CONTRACTOR SHALL NOTIFY THE ARCHITECT / ENGINEER IMMEDIATELY IF ANY DISCREPANCIES ARE ENCOUNTERED BETWEEN THE DRAWINGS AND THE FIELD CONDITIONS. ANY DISCREPANCIES SHALL BE RESOLVED BY ARCHITECT / ENGINEER PRIOR TO PROCEEDING WITH THE WORK.
  - 49. PRIOR TO COMMENCING WORK, THE CONTRACTOR SHALL VERIFY LOCATION OF ALL EQUIPMENT AND UTILITIES TO BE REMOVED. REMOVALS SHALL BE COORDINATED WITH THE OWNER AND ARCHITECT / ENGINEER.
  - 50. THE CONTRACTOR SHALL BE RESPONSIBLE FOR THE PROTECTION OF HIS OR HER WORK, INCLUDING, BUT NOT LIMITED TO FROM VANDALISM, THEFT, THE WEATHER, ETC. ADDITIONALLY, THE CONTRACTOR SHALL BE RESPONSIBLE FOR THE OWNER'S PROPERTY, INCLUDING, BUT NOT LIMITED TO ANY DAMAGE, VANDALISM, THEFT, OR THE WEATHER.
  - THE CONSTRUCTION SHALL INCLUDE THE FURNISHING OF ALL MATERIALS, EXTENSIONS, TEMPORARY AND PERMANENT CONNECTIONS, CUTTING, PATCHING, PAINTING, REPAIRING ADAPTING, AND OTHER WORK INCIDENTAL TO FINISHED RESULTS DELINEATED IN THE DRAWINGS AND SPECIFIED IN THE PROJECT MANUAL. ANY WORK, MATERIALS OR PRODUCTS NOT SHOWN ON THE DRAWING OR SPECIFICALLY MENTIONED IN THE SPECIFICATIONS BUT CONSIDERED NECESSARY FOR THE COMPLETION OF THE WORK IN A PROPER MANNER SHALL BE PROVIDED BY THE CONTRACTOR WITHOUT ADDITIONAL CHARGE.
  - 52. WHERE EXISTING CONSTRUCTION IS DAMAGED IN THE EXECUTION OF THIS CONTRACT, OR WHERE OPENINGS ARE LEFT DUE TO THE REMOVAL OF PIPES, EQUIPMENT OR APPARATUS, THE OPENINGS SHALL BE REPAIRED OR CLOSED UP TO CORRESPOND IN MATERIAL, QUALITY, SHAPE AND FINISH WITH THAT OF SIMILAR AND ADJOINING WORK, UNLESS OTHERWISE CALLED FOR. WHERE DAMAGE IS NOT REPAIRABLE, NEW ITEMS OR EQUIPMENT SHALL BE PROVIDED.
  - 53. THE CONTRACTOR SHALL COORDINATE AND SCHEDULE THE WORK OF ALL TRADES TO INSURE THE WORK IS COMPLETED IN A TIMELY MANNER, COMPLYING WITH THE OWNER / CONTRACTOR AGREEMENT.
  - 54. THE CONTRACTOR SHALL REPLACE DAMAGED, SOILED OR STAINED CEILING TILES THAT ARE AFFECTED DUE TO CONSTRUCTION TO MATCH EXISTING.
  - 55. THE CONTRACTOR SHALL PATCH AND REPAINT EXISTING WALL AND HARD CEILING FINISHES WHICH BECOME DISTURBED, DAMAGED OR SOILED BY DEMOLITION OR CONSTRUCTION ACTIVITIES, AND WHERE REPAINTING, THE ENTIRE AFFECTED WALL OR CEILING PLANE SHALL BE REPAINTED - SPOT REPAINTING IS NOT ACCEPTABLE.
  - CLEANING: REMOVE RUBBISH AND DEBRIS DAILY. LEAVE JOB CLEAN UPON COMPLETION OF WORK, INCLUDING CLEANING HARDWARE, FIXTURES AND GLASS, AND REMOVING OF STAINS, DUST AND DIRT. POLISH ALL FINISHED FLOORS.
  - 57. GLAZING SPARE PARTS: SYSTEM SHALL BE WARRANTED FOR A PERIOD OF 2 YEARS. ALL REPLACEMENT PARTS SHALL BE AVAILABLE INDIVIDUALLY WITHOUT THE NEED FOR PURCHASING THE ENTIRE ASSEMBLY. PROVIDE 10% SPARE PARTS (ENTIRE ASSEMBLY) AS PART OF THE CONTRACT DOCUMENTS FOR GLAZING FIXTURES.
  - <u>COMMUNICATION</u> ALL COMMUNICATION ON THIS PROJECT SHALL TAKE PLACE THROUGH THE RESIDENT PROJECT REPRESENTATIVE (RPR) APPOINTED BY MDAD.
  - CONSTRUCTION AREA LIMITS ALL CONTRACTOR VEHICLES AND TRAFFIC SHALL REMAIN WITHIN THE LIMITS OF CONSTRUCTION AREAS, STAGING AREAS OR HAUL ROUTES AS SHOWN ON THE PLANS.
  - 60. EXISTING UTILITIES THERE ARE A NUMBER OF AIRPORT, PUBLIC UTILITIES AND FAA LIGHTING, COMMUNICATIONS, UNDERGROUND CABLES AND PIPES TRAVERSING THE EXISTING SITE. THESE DRAWINGS SHOW EXISTING CONDITIONS BASED ON MDAD PROVIDED AS-BUILT DRAWINGS, WHICH IS THE MOST RELIABLE AND BEST AVAILABLE SOURCE, THIS INFORMATION IS NOT GUARANTEED AND IT IS THE CONTRACTOR'S RESPONSIBILITY TO FIELD VERIFY ALL HORIZONTAL AND VERTICAL UTILITY INFORMATION AND DETERMINE THE EXACT LOCATION PRIOR TO CONSTRUCTION.

61. <u>FOR UTILITIES INFORMATION</u>

MDAD IRRIGATION

FRANK CONTRERAS

MDAD UTILITIES COORDINATOR JONATHAN SPICER SUNSHINE STATE ONE-CALL OF FLORIDA

CONTRACT WITH NO ADDITIONAL COMPENSATION

- (305) 876-7341(800) 432-4770 (305) 345-3229
- **BOB GARDNER** (305) 345-2145ROBERT SULLIVAN JOSE HERNANDEZ (305) 869-5349
- <u>BLACK BOX COMMUNICATION</u> (305) 876-8416/(305) 876-8406 STEVE LOW
  - EDITION. (305) 844-9321 (305) 869-7341/(305) 369-7746
  - THE CONTRACTOR SHALL REPAIR AND UTILITY DAMAGED, CAUSED BY HIS ACTIONS, WITH NO ADDITIONAL COMPENSATION. UTILITY CLEARANCE ACTIVITIES PERFORMED BY THE DURING CONSTRUCTION. CONTRACTOR SHALL BE CONSIDERED INCIDENTAL TO THE
- 62. <u>NIGHT CONSTRUCTION</u> CONTRACTOR SHALL PROVIDE AN ADEQUATE NUMBER OF PORTABLE FLOOD LIGHT UNITS WITH GENERATORS TO ILLUMINATE WORK AREAS AT NIGHT.
- 63. <u>COORDINATION</u> CLOSE COORDINATION OF ALL WORK WILL BE ADDRESSED DAILY WITH THE RPR TO INSURE ALL PARTIES CAN COOPERATIVELY ACCOMPLISH THEIR WORK AS CONTRACTED.
- 64. MONITORING WELLS IF ANY MONITORING WELLS ARE ENCOUNTERED DURING CONSTRUCTION ACTIVITIES THAT WERE NOT PREVIOUSLY IDENTIFIED IN THE ORIGINAL CONSTRUCTION PLANS FOR THIS FACILITY, PLEASE INFORM RPR WHO WILL COORDINATE WITH MDAD ENVIRONMENTAL ENGINEERING TO DETERMINE WHAT STEPS WILL NEED TO BE FOLLOWED.
- 65. THE CONSTRUCTION DOCUMENTS ARE CERTIFIED TO BE COMPLIANT WITH REQUIREMENTS FOR ADA ACCESSIBILITY GUIDELINES (ADAAG) AND UNIFORM ACCESSIBILITY STANDARDS (UFAS), WHERE APPLICABLE.

NOTE: PRODUCTS OR MATERIALS SPECIFIED OR INDICATED ARE TO PROVIDE THE QUALITY AND PERFORMANCE REQUIREMENTS FOR THE PROJECT. APPROVED EQUALS MAY BE ACCEPTED.

THE CURTAIN WALL SYSTEM FOR THE BUILDING HAS BEEN DESIGNED IN ACCORDANCE WITH THE FLORIDA BUILDING CODE, 7TH EDITION THE FOLLOWING SUPERIMPOSED LOADING HAS BEEN UTILIZED:

WIND LOAD: 186 MPH AS PER ASCE 7-16 EXPOSURE C CATEGORY III WIND DIRECTIONALITY FACTOR Kd=0.85 USED FOR WINDOWS ELASTIC (ASD) WIND PRESSURES ON THE STRUCTURE ARE:

- (LOAD CONVERSION FROM ULT TO ELASTIC IS 0.6) FLORIDA BUILDING CODE, BUILDING FLORIDA BUILDING CODE, EXISTING BUILDING
- LIFE SAFETY CODE, NFPA 101 NFPA, (ALL APPLICABLE CHAPTERS), REFER TO NFPA 101: 4.6.10. CONSTRUCTION, REPAIR, AND IMPROVEMENT OPERATIONS. NFPA 1: CH 16: SAFEGUARDING CONSTRUCTION, ALTERATIONS AND DEMOLITION OPERATIONS. REFER TO NFPA 415 STANDARD ON AIRPORT TERMINAL BUILDINGS.
- ICC / ANSI A117.1 NATIONAL ELECTRIC CODE FLORIDA FIRE PREVENTION CODE, 7TH EDITION
- LOCAL ORDINANCES: AS REQUIRED BY LOCAL AUTHORITIES THESE PLANS COMPLY WITH THE PROVISION OF TITLE III OF THE "AMERICANS WITH DISABILITIES ACT" (ADA)

### APPLICABLE CODES N.T.S.

- CURTAIN WALL MATERIALS REMOVED FROM THE SITE MUST BE SENT TO AN AUTHORIZED FLORIDA DEPARTMENT OF ENVIRONMENTAL PROTECTION (FDEP) HAULER/RECYCLER FOR PROPER DISPOSAL.
- ALL HAZARDOUS AND NON-HAZARDOUS WASTE LIKE PAINTS, CONSTRUCTION MATERIALS, ETC. MUST BE REMOVED FROM THE SITE AND DISPOSED OF PROPERLY UPON THE COMPLETION OF THE PROJECT AND ON A DAILY BASIS.

#### WASTE MATERIAL NOTES N.T.S.

- SHOP DRAWING REVIEW IS ONLY FOR GENERAL CONFORMANCE WITH DESIGN CONCEPT AND INTENT OF CONTRACT DOCUMENTS CONTRACTOR IS SOLELY RESPONSIBLE FOR VERIFYING DIMENSIONS FOR ESTABLISHING FABRICATION PROCESSES, MEANS, TECHNIQUES, SEQUENCES AND PROCEDURES OF CONSTRUCTION, AND FOR COORDINATION OF WORK OF ALL TRADES. EXCEPTIONS TAKEN AND NOTED TO INFORMATION SHOWN DOES NOT AUTHORIZE WORK RESULTING IN CONTRACT COST REVISIONS UNLESS SO STATED IN SEPARATE LETTER OR
- SHOP DRAWINGS WILL NOT BE REVIEWED BY THE DESIGN PROFESSIONAL UNLESS THE DRAWINGS HAVE BEEN PREVIOUSLY REVIEWED BY THE CONTRACTOR AND STAMPED APPROVED.
- GENERAL CONTRACTOR SHALL PROVIDE THE DESIGN PROFESSIONAL A SEPIA FOR CORRECTIONS OF SHOP DRAWINGS THAT ARE COMPLICATED AND REQUIRE AMPLE TIME FOR REVIEW.
- GENERAL CONTRACTOR SHALL ALLOW THE DESIGN PROFESSIONAL A MINIMUM OF 2 WEEKS FOR SHOP DRAWING REVIEW FOR EACH SHOP DRAWING. MULTIPLE SUBMITTAL WILL NOT BE ACCEPTED FOR REVIEW AT THE SAME TIME. IF THE CONTRACTOR SUBMITS MULTIPLE SHOP DRAWINGS, THE DESIGN PROFESSIONAL RESERVES THE RIGHT TO ALLOW AMPLE TIME FOR REVIEW, AND IT IS THE RESPONSIBILITY OF THE CONTRACTOR TO SUBMIT A CONSTRUCTION SCHEDULE TO INFORM THE DESIGN PROFESSIONAL WHICH SHOP DRAWINGS HAVE PRECEDENCE.
- SUBMIT SHOP DRAWINGS FOR THE FOLLOWING ITEMS: MISC. STEEL, GLAZING TRIMS, PAINT, CURTAIN WALL

- GENERAL THE CONTRACTOR SHALL DESIGNATE IN WRITING TO MDAD THE NAME OF THE "CONTRACTOR SAFETY AND SECURITY OFFICER". THE CONTRACTOR SAFETY AND SECURITY OFFICER SHALL REPRESENT THE CONTRACTOR ON THE SAFETY AND SECURITY REQUIREMENTS OF THE CONTRACT.
- CONTRACTOR PERSONNEL SAFETY AND SECURITY ORIENTATION - THE CONTRACTOR SECURITY OFFICER SHALL BE RESPONSIBLE TO BRIEF ALL CONTRACTOR AND SUBCONTRACTOR PERSONNEL ON CONTRACT SAFETY AND SECURITY REQUIREMENTS FOR WORKING ON THE AOA. INCLUDING THE FOLLOWING FAA ADVISORY CIRCULARS LATEST
  - 150/5370-2 OPERATIONAL SAFETY ON AIRPORTS DURING CONSTRUCTION. 150/5210-5 - PAINTING, MARKING, AND LIGHTING OF VEHICLES USED ON AN AIRPORT. 150/5340-1 - STANDARDS FOR AIRPORT MARKINGS. DIVÍSION 1-01570 - AIRFIELD OPERATIONAL SAFETY
- GROUND CONTROL ALL CONTRACTOR VEHICLES THAT ARE REQUIRED TO ACCESS OR CROSS ACTIVE RUNWAYS, TAXIWAYS, SAFETY AREA AND APPROACH CLEAR ZONES SHALL DO SO UNDER THE DIRECT CONTROL AND COORDINATION OF MDAD AIRSIDE OPERATIONS. ALL CONTRACTOR MOVEMENT ON THE AOA SHALL BE CONTROLLED BY MDAD AIRSIDE OPERATIONS.
- MOT CONSTRUCTION WORK SHALL BE PERFORMED IN ACCORDANCE WITH THE CONSTRUCTION SAFETY AND PHASING PLANS (MOT) AND THE PROJECT MANUAL. NO RUNWAY, TAXIWAY, APRON OR AIRPORT ROADWAY SHALL BE CLOSED WITHOUT APPROVAL OF MDAD AIRSIDE OPERATIONS. A MINIMUM OF SEVENTY-TWO (72) HOURS WRITTEN NOTICE OF REQUESTED CLOSING SHALL BE SUBMITTED TO THE FIELD REPRESENTATIVE, WHO WILL COORDINATE THE REQUEST WITH MDAD AIRSIDE OPERATIONS.

OPEN FLAME - OPEN FLAME, WELDING OR TORCH-CUTTING OPERATIONS ARE PROHIBITED UNLESS A MDAD HOT WORK PERMIT HAS BEEN SUBMITTED TO AND APPROVED BY MDAD THROUGH THE RPR AND IN ACCORDANCE WITH DEMOLITION NFPA 1;241;51B; HOT WORK PERMIT.

STOCKPILE AND DUST CONTROL - STOCKPILED MATERIAL AND DUST CONTROL SHALL BE TREATED IN SUCH A MANNER AS TO PREVENT MOVEMENT RESULTING FROM AIRCRAFT BLAST OR WIND CONDITIONS IN EXCESS OF 10 KNOTS. STOCKPILED MATERIALS SHALL NOT BE PERMITTED WITHIN THE R.S.A. OR THE T.S.A. AND SHALL ONLY BE PLACED IN APPROVED AREAS DEBRIS WASTE AND LOOSE MATERIAL SHALL NOT BE ALLOWED ON ACTIVE AIRCRAFT MOVEMENT AREAS. THE CONTRACTOR SHALL HAVE AN AUTOMATIC MOTORIZED VACUUM SWEEPER <u>OPERATING ON THE WORKSITE AND HAUL ROUTES AT ALL</u> TIMES. MDAD AIRSIDE OPERATIONS OR THE FIELD REPRESENTATIVE MAY DIRECT THAT DEBRIS PROBLEMS DURING CONSTRUCTION NOT CORRECTED BY THE CONTRACTOR BE CORRECTED BY OTHERS AT THE EXPENSE OF THE CONTRACTOR.

USE OF RUNWAYS OR TAXIWAYS DURING OPERATIONAL EMERGENCIES - MDAD MAY DIRECT THE CONTRACTOR TO CEASE ALL CONSTRUCTION ACTIVITIES AND EVACUATE ALL EQUIPMENT, PERSONNEL, AND MATERIALS FROM THE AOA DURING AN OPERATIONAL EMERGENCY. THE CONTRACTOR WILL IMPLEMENT THIS EVACUATION IMMEDIATELY AND RELEASE THE CONSTRUCTION AREA TO MDAD AIRSIDE OPERATIONS WITHIN 30 MINUTES.

- INSPECTION BY MDAD OPERATIONS UPON COMPLETION OF THE CONTRACTOR'S WORK AND PRIOR TO OPENING FOR AIRCRAFT USE, THE RPR WILL ARRANGE FOR INSPECTIONS BY MDAD AIRSIDE OPERATIONS AND THE A/E OF THE WORKSITE. THESE AREAS MUST COMPLY WITH REQUIREMENTS OF THE CONTRACT DOCUMENTS FOR THE ACCEPTANCE AND PASS THE INSPECTION BY MDAD AIRSIDE OPERATIONS.
- MAINTENANCE OF TRAFFIC DEVICES ALL BARRICADE LIGHTING. TEMPORARY SIGNAGE AND SIGNAGE LIGHTING COVERS SHALL BE VERIFIED BY THE CONTRACTOR FOR PROPER OPERATION EACH DAY. IN ADDITION, THE CONTRACTOR SHALL IMMEDIATELY REPLACE ANY BARRICADES, LIGHTS OR FLAGS WHICH IN THE OPINION OF THE FIELD REPRESENTATIVE OR MDAD AIRSIDE OPERATIONS ARE NOT ADEQUATE. REFER TO DIVISION 1-01570 AIRFIELD OPERATIONAL SAFETY DURING CONSTRUCTION.
- ACCESS ROUTE ACCESS ROUTES WITHIN THE AOA SHALL BE AS APPROVED BY MDAD, IT SHALL BE THE CONTRACTOR'S RESPONSIBILITY TO COORDINATE OFF-AIRPORT HAUL ROUTES (STATE HIGHWAYS, COUNTY ROADS OR CITY STREETS) WITH THE APPROPRIATE OWNER WHO HAS JURISDICTION OVER THE AFFECTED ROUTE. THE CONTRACTOR IS RESPONSIBLE FOR THE IMMEDIATE CLEANUP OF ANY DEBRIS DEPOSITED ALONG ANY ACCESS ROAD AS A RESULT OF THE CONSTRUCTION TRAFFIC. DIRECTIONAL SIGNING AT THE ACCESS GATE AND ALONG THE DELIVERY ROUTE TO THE STORAGE AREA OR WORK SITE SHALL NOT BE PERMITTED. THE CONTRACTOR SHALL RESTORE ACCESS ROUTE PAVEMENTS AND EQUIPMENT TO ITS ORIGINAL CONDITION OR BETTER AT NO ADDITIONAL COMPENSATION AT THE CONCLUSION OF PAVING AND HAULING OPERATIONS.
- CONSTRUCTION AREA LIMITS THE CONTRACTOR'S STAGING, PARKING AREA AND OTHER AREAS REQUIRED FOR THE CONTRACTOR'S EXCLUSIVE USE DURING CONSTRUCTION SHALL BE MARKED BY THE CONTRACTOR AND APPROVED BY THE RPR. THE CONTRACTOR SHALL ERECT AND MAINTAIN SUITABLE FENCING, SIGNAGE AND WARNING DEVICES VISIBLE FOR BOTH DAY/NIGHT USE TO DELINEATE THE PERIMETER OF ALL STAGING AND PARKING AREAS. HOWEVER, THE CONTRACTOR IS RESPONSIBLE FOR SECURING ALL EQUIPMENT AND MATERIALS. THE MDAD IS NOT RESPONSIBLE FOR EQUIPMENT OR MATERIALS DAMAGED AND/OR STOLEN FROM THE CONTRACTOR'S STAGING AREA.
- <u>IDENTIFICATION BADGES</u> ALL CONTRACTOR EMPLOYEES AND EMPLOYEES OF APPROVED SUBCONTRACTORS SHALL BE IDENTIFIED BY MEANS OF MDAD ISSUED IDENTIFICATION BADGES AT ALL TIMES WHEN THEY ARE INSIDE THE AOA. THE AIRPORT I.D. PROGRAM IS UNDER CONSTANT REVIEW BY THE TRANSPORTATION SECURITY ADMINISTRATION AND ALL CURRENT REQUIREMENTS WILL GOVERN. THE CONTRACTOR'S SAFETY AND SECURITY OFFICER IS RESPONSIBLE FOR ALL IDENTIFICATION AND BADGING REQUIREMENTS. ALL OTHER REQUIREMENTS OF THE AIRPORT'S WRITTEN POLICY ON AIRPORT CONSTRUCTION IDENTIFICATION BADGING SHALL BE ADHERED TO INCLUDING ANY APPLICABLE UPDATES OR CHANGES WHICH BECOME EFFECTIVE DURING THE COURSE OF THE PROJECT.
- BACKGROUND CHECKS THE CONTRACTOR IS ADVISED THAT ALL EMPLOYEES WHO ARE BADGED AND ALLOWED TO WORK ON THE AOA UNESCORTED MUST BE SUBJECTED TO A TEN-YEAR BACKGROUND CHECK IF THE EMPLOYEE WAS HIRED AFTER NOVEMBER 1, 1985. NO DEVIATIONS FROM THIS REQUIREMENT WILL BE PERMITTED AND THE CONTRACTOR SHALL BEAR ALL COSTS FOR SUCH CHECKS. THE CONTRACTOR SHALL BE RESPONSIBLE FOR ANY AND ALL FINES LEVIED BY THE TSA FOR CONTRACTOR'S NONCOMPLIANCE WITH SECURITY AND

- 14. <u>AOA DRIVER'S CERTIFICATION</u> OPERATORS OF VEHICLES MUST POSSESS A VALID DRIVER'S LICENSE, FOR THE VEHICLE BEING OPERATED. ALL PERSONNEL DRIVING WITHIN THE AOA ARE REQUIRED TO SUCCESSFULLY COMPLETE MDAD'S VEHICLE OPERATOR CLASS. ALL VEHICLES ON AOA SHALL HAVE MDAD PERMIT DISPLAYED, WITH EXCEPTION OF APPROVED MDAD ESCORTED DELIVERY VEHICLES.
- 15. <u>VEHICLE IDENTIFICATION</u> THE CONTRACTOR, SHALL ESTABLISH AND MAINTAIN A LIST OF CONTRACTOR AND SUBCONTRACTOR VEHICLES AUTHORIZED TO OPERATE ON THE AOA. THE CONTRACTOR SHALL PROVIDE A CURRENT LISTING OF VEHICLES AND COMPANIES AUTHORIZED TO ENTER AND CONDUCT WORK ON THE AOA TO THE FIELD REPRESENTATIVE CONTRACTOR'S EMPLOYEE PERSONAL VEHICLES ARE NOT ALLOWED ON THE AOA AT ANY TIME. ALL CONTRACTOR COMPANY OWNED OR LEASED VEHICLES THAT ARE AUTHORIZED TO OPERATE ON THE AOA SHALL COMPLY WITH THE REQUIREMENTS OF FAA AND MDAD AIRSIDE OPERATIONS.

THE WORK WILL OCCUR IN DIFFERENT PHASES / STAGES AND

TIMES AS REQUIRED FOR THE COMPLETION OF THE WORK.

THE WORK SHALL BE PHASED / SCHEDULED AROUND MDAD

OPERATION, AND SHALL OCCUR ONLY IN AREAS ALLOWED /

CONTRACTOR SHALL SUBMIT SAFETY PLAN FOR APPROVAL

CONSTRUCTION, SAFELY BARRIERS, EXITS, CONSTRUCTION

TRAFFIC DURING THE VARIOUS PHASES OF THE PROJECT AND

SECURE DOUBLE BARRIERS WITH A DISTANCE OF 10 FEET IN

BETWEEN. CONSTRUCTION, IT'S STAGING, ETC. SHALL NOT

PROVIDE AND MAINTAIN STABILIZED VEHICULAR ACCESS TO

IMPEDE OR REDUCE THE MEANS OF EGRESS.

PROVIDE AND MAINTAIN ACCESS TO STAGING AND

WHEN CONDITIONS CHANGE. WHERE HEAVY MACHINERY IS TO BE

USED, THE WORK SHALL BE SEPARATED FROM OCCUPANTS BY

SAFETY PLAN SHALL CLEARLY DELINEATE AREAS FOR

ASSIGNED BY MDAD.

CONSTRUCTION AREAS.

CONSTRUCTION AREAS.

SHALL BE SCHEDULED ACCORDINGLY. DEMOLITION, BARRICADES

INSTALLATION / REMOVAL, MOBILIZATION WILL OCCUR AS MANY



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Enrique M. Zúñiga, P.E. PE 3888

ENRIQUE M. ZÚÑIGA

PROVIDE TEMPORARY CONSTRUCTION BARRICADES TO THE EXTENT REQUIRED TO ALLOW DEMOLITION AND NEW CONSTRUCTION TO OCCUR IN A SAFE MANNER, MAINTAIN SAFE EGRESS AND ACCESS TO AND FROM ALL REMAINING OCCUPIED BUILDINGS.

- ALL SYSTEMS SHALL REMAIN OPERATIONAL DURING ALL PHASES OF CONSTRUCTION. TRANSFER, RELOCATION, OR REMOVAL OF ANY SYSTEM SHALL BE PERFORMED IN SUCH A MANNER THAT SCHOOL OPERATION WILL BE MAINTAINED WITH ALL SYSTEMS IN A SAFE, WORKING ORDER.
- REMOVE TEMPORARY BARRIERS UPON COMPLETION OF THE WORK RESTORE ALL AREAS DAMAGED DURING CONSTRUCTION TO A "LIKE NEW" CONDITION, INCLUSIVE OF LANDSCAPE AREAS, FLOORS WALLS, CEILINGS, UTILITIES, BELOW AND ABOVE GRADE IMPROVEMENTS, ETC. PROVIDE PHOTOGRAPHS RECORDING EXISTING CONDITIONS PRIOR TO COMMENCING THE WORK.
- PROVIDE SIGNS ON EXTERIOR FACE OF TEMPORARY CONSTRUCTION BARRIERS TO READ: "CONSTRUCTION AREA NO
- TRESPASSING". 10. RESTORE AREAS AFTER WORK IS COMPLETED TO A MATCHING
- FINISHED APPEARANCE. 1. NO WORK OF ANY PHASE SHALL START UNTIL PREVIOUS PHASE HAS BEEN ACCEPTED BY OWNER AND ARCHITECT / ENGINEER
- AS SUBSTANTIALLY COMPLETE. 2. REPLACE, REPAIR, REFINISH ALL EXISTING IMPROVEMENTS DAMAGED DURING CONSTRUCTION
- 13. PROVIDE VIDEO TAPED / PHOTOGRAPH RECORD CONDITIONS OF AREAS TO REMAIN THAT WILL BE IMPACTED DURING ALL PHASES OF CONSTRUCTION.
- 14. STAGING AREAS SHALL BE MINIMIZED TO MAINTAIN PROPER SAFE OPERATIONS. THEY SHALL BE INSTALLED AND / OR SHALL BE RELOCATED AS WORK PROGRESSES.
- 15. PHASING OF THE WORK SHALL BE SUBJECT TO THE APPROVAL OF MDAD. INTERRUPTION OF EXISTING FACILITIES OR SERVICES SHALL BE KEPT TO A MINIMUM AND THE CONTRACTOR SHALL FURNISH ALL MATERIALS REQUIRED WHENEVER TEMPORARY CONNECTIONS ARE NECESSARY TO MAINTAIN CONTINUITY OF SERVICE. INTERRUPTION OF EXISTING SERVICES, THE INSTALLATION OF TEMPORARY FACILITIES, AND THE WORK OF MAKING FINAL CONNECTIONS SHALL BE DONE ONLY AT SUCH TIMES PERMITTING BY THE OWNER. CARE MUST BE USED IN WORKING AROUND UTILITY LINES RUNNING THROUGH AREAS BEING DEMOLISHED SO THAT SERVICES TO OTHER AREA WHICH MIGHT BE SERVED THROUGH THESE AREAS WILL NOT BE INTERRUPTED.

THE CONSTRUCTION SHALL INCLUDE THE FURNISHING OF ALL

MATERIALS, EXTENSIONS, CONNECTIONS, CUTTING, PATCHING, PAINTING, REPAIRING, ADAPTING AND OTHER WORK, INCIDENTAL TO, AND TOGETHER WITH SUCH TEMPORARY CONNECTIONS AS MAY BE REQUIRED. THE CONSTRUCTION SHALL ALSO INCLUDE THE REMOVAL OF MATERIALS AS DIRECTED. ANY WORK NOT SHOWN ON THE DRAWING OR SPECIFICALLY MENTIONED IN THE SPECIFICATIONS BUT CONSIDERED NECESSARY FOR THE COMPLETION OF THE WORK IN PROPER MANNER SHALL BE PROVIDED BY THE CONTRACTOR WITHOUT ADDITIONAL CHARGE. WHERE PRESENT WORK IS DAMAGE IN THE EXECUTION OF THIS CONTRACT, OR WHERE OPENINGS ARE LEFT DUE TO THE REMOVAL OF PIPES, EQUIPMENT OR APPARATUS, THE SAME SHALL BE REPAIRED OR CLOSED UP TO CORRESPOND IN MATERIAL, QUALITY, SHAPE, AND FINISH WITH THAT OF SIMILAR AND ADJOINING WORK, UNLESS OTHERWISE CALLED FOR WHERE DAMAGE IS NOT REPAIRABLE, NEW ITEMS OR EQUIPMENT SHALL BE PROVIDED. INTERRUPTION OF EXISTING FACILITIES OR SERVICES SHALL BE KEPT TO A MINIMUM AND THE CONTRACTOR SHALL FURNISH ALL MATERIALS REQUIRED WHENEVER TEMPORARY CONNECTIONS ARE NECESSARY TO MAINTAIN CONTINUITY OF SERVICE. INTERRUPTION OF EXISTING SERVICES, THE INSTALLATION OF TEMPORARY FACILITIES, AND THE WORK OF MAKING FINAL CONNECTIONS TO THE NETWORK SHALL BE DONE ONLY AT SUCH TIMES AS PERMITTED AND SCHEDULED BY THE OWNER WITHOUT ADDITIONAL COST. CARE MUST BE USED IN RESOLVING SERVICES TO AREA BEING DEMOLISHED SO THAT SERVICES TO OTHER AREAS WHICH MIGHT BE SERVED THROUGH THESE AREAS WILL NOT BE INTERRUPTED. WHERE WORK IS SHOWN TO BE REMOVED. CONTRACTOR SHALL CAP AND SEAL EXISTING SANITARY AND WATER LINES AS REQUIRED.

FLORIDA, P.E. No. 38883

0 0 uth

**FEBRUARY 4, 2022** AS SHOWN DESIGN BY DRAWN BY: REVIEWED BY: E.M.Z

PROJECT NO .:

DRAWING TITLE:

NOTES, CODES & SYMBOLS DRAWING NO .:

18-0305.02

CHANGE ORDER.


4 SHOP DRAWING NOTES


SAFETY AND SECURITY NOTES


6 PHASING NOTES

**GENERAL NOTES** 


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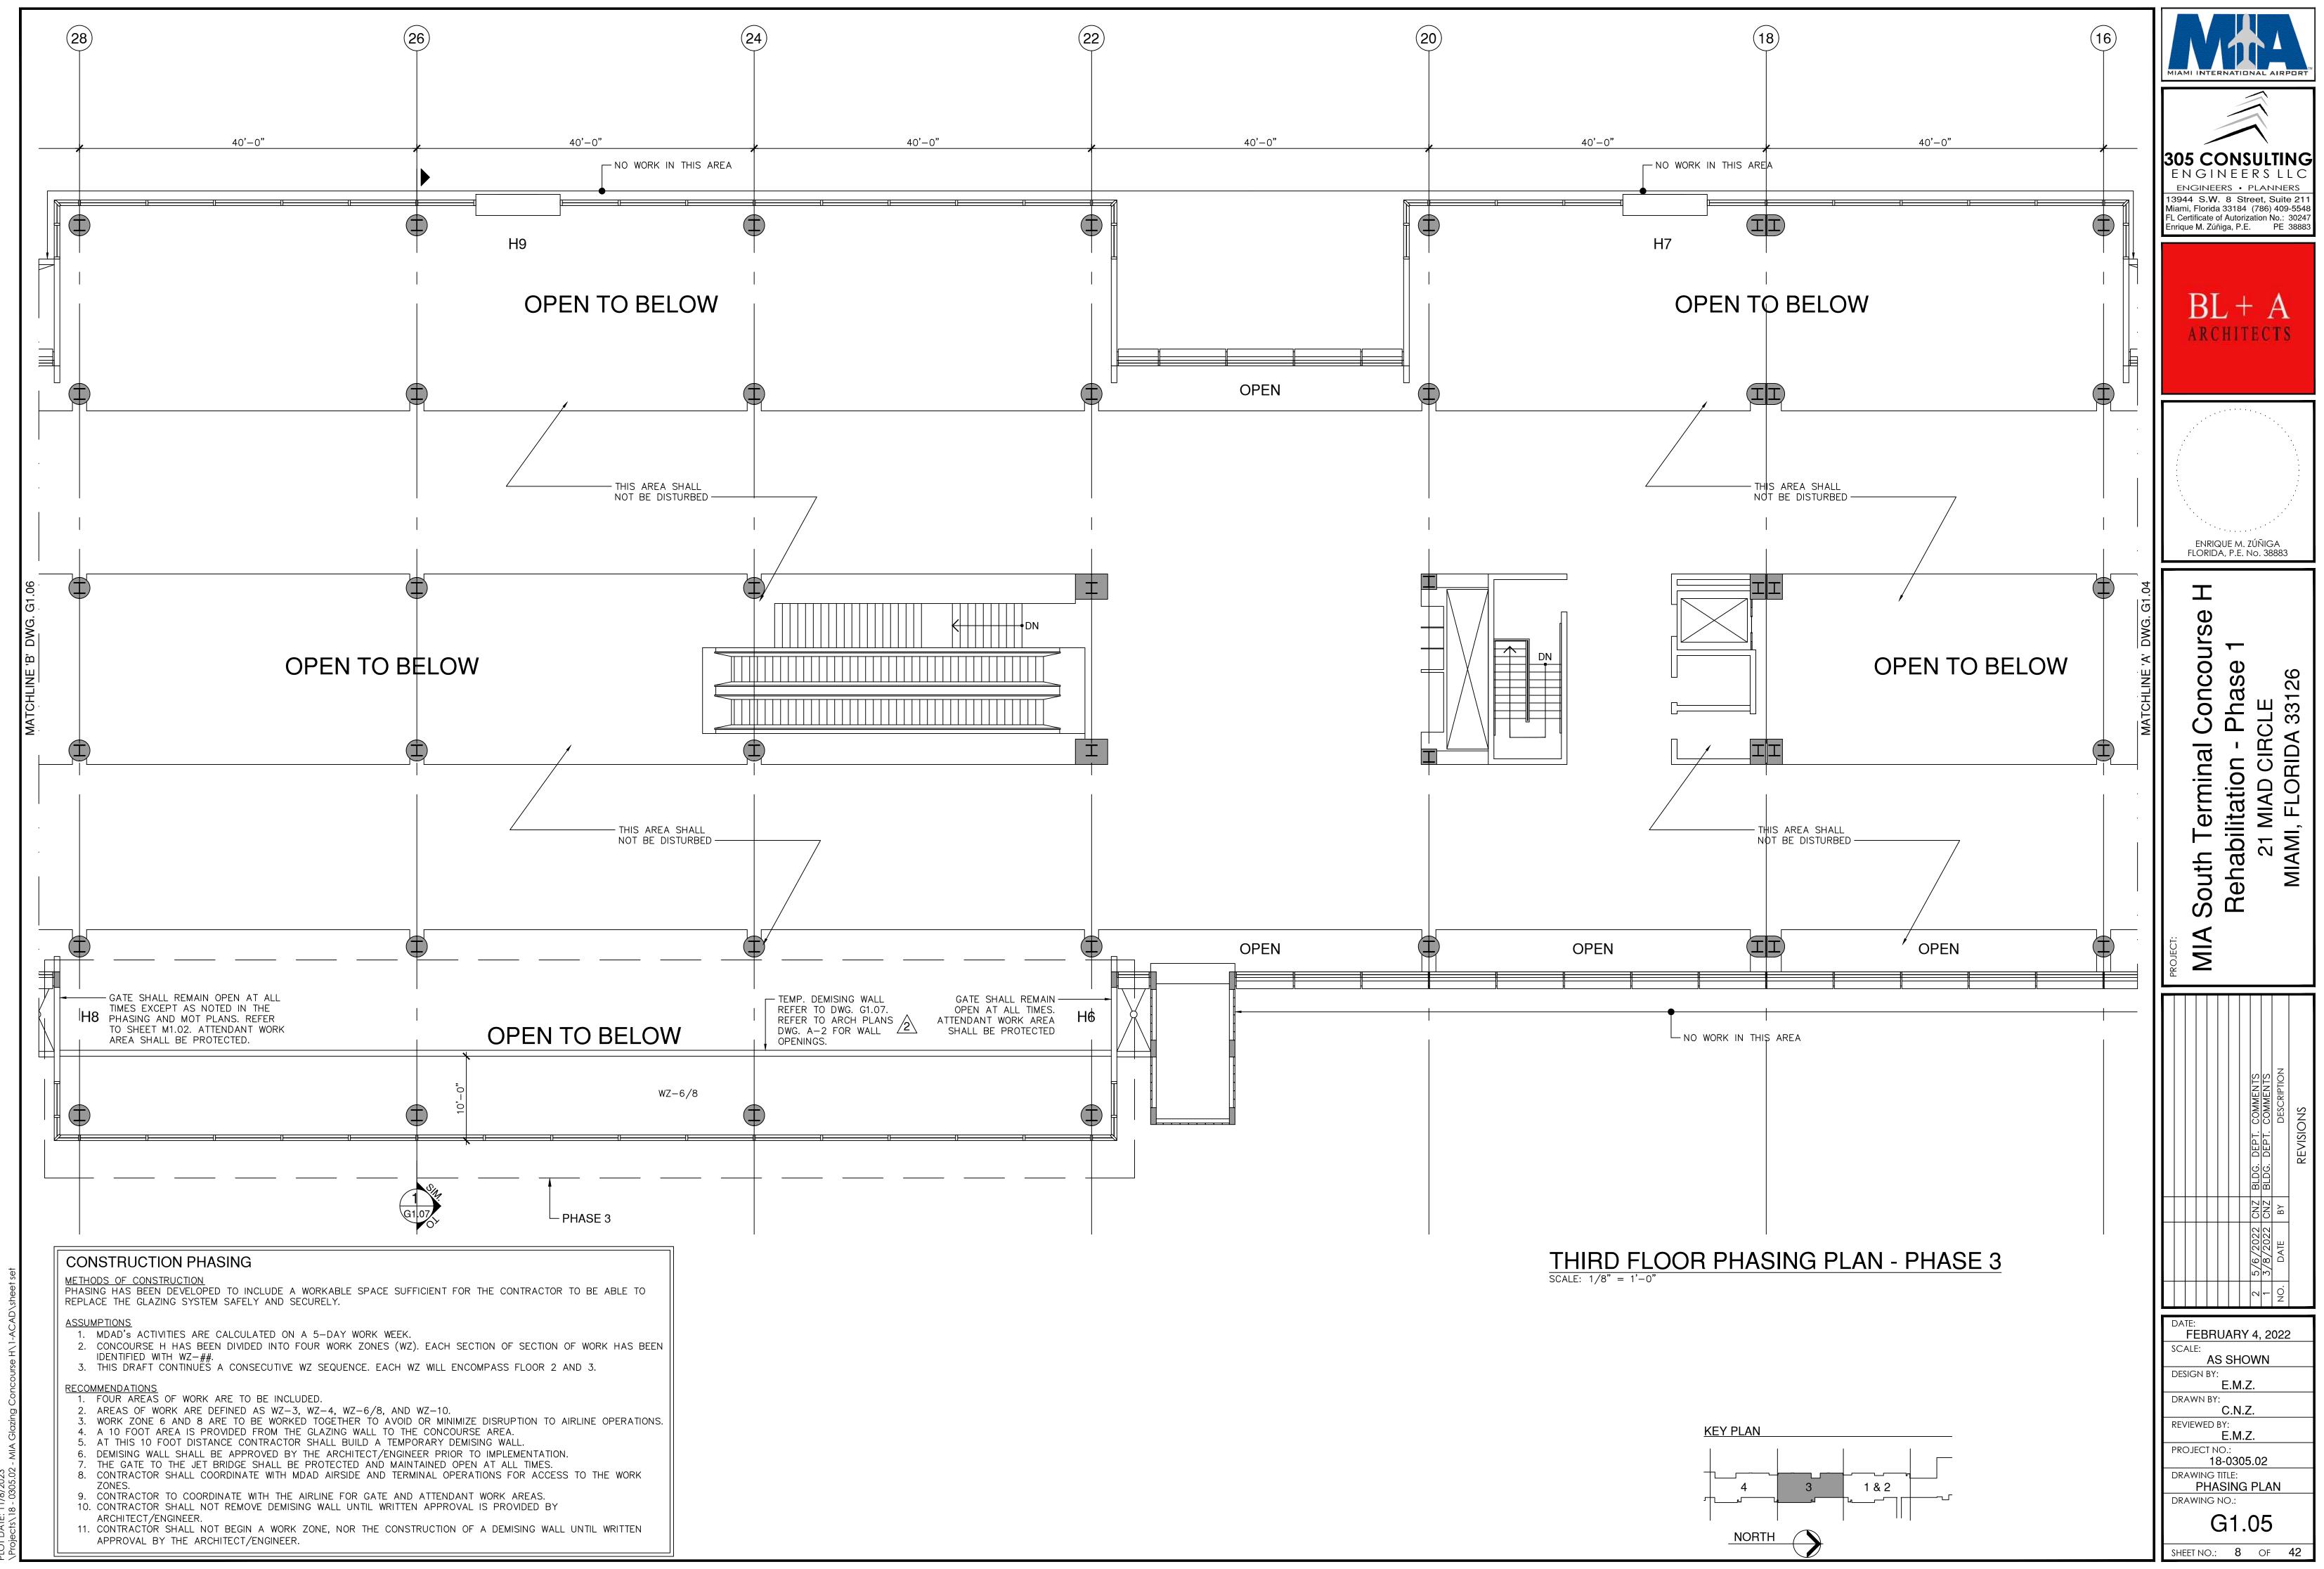


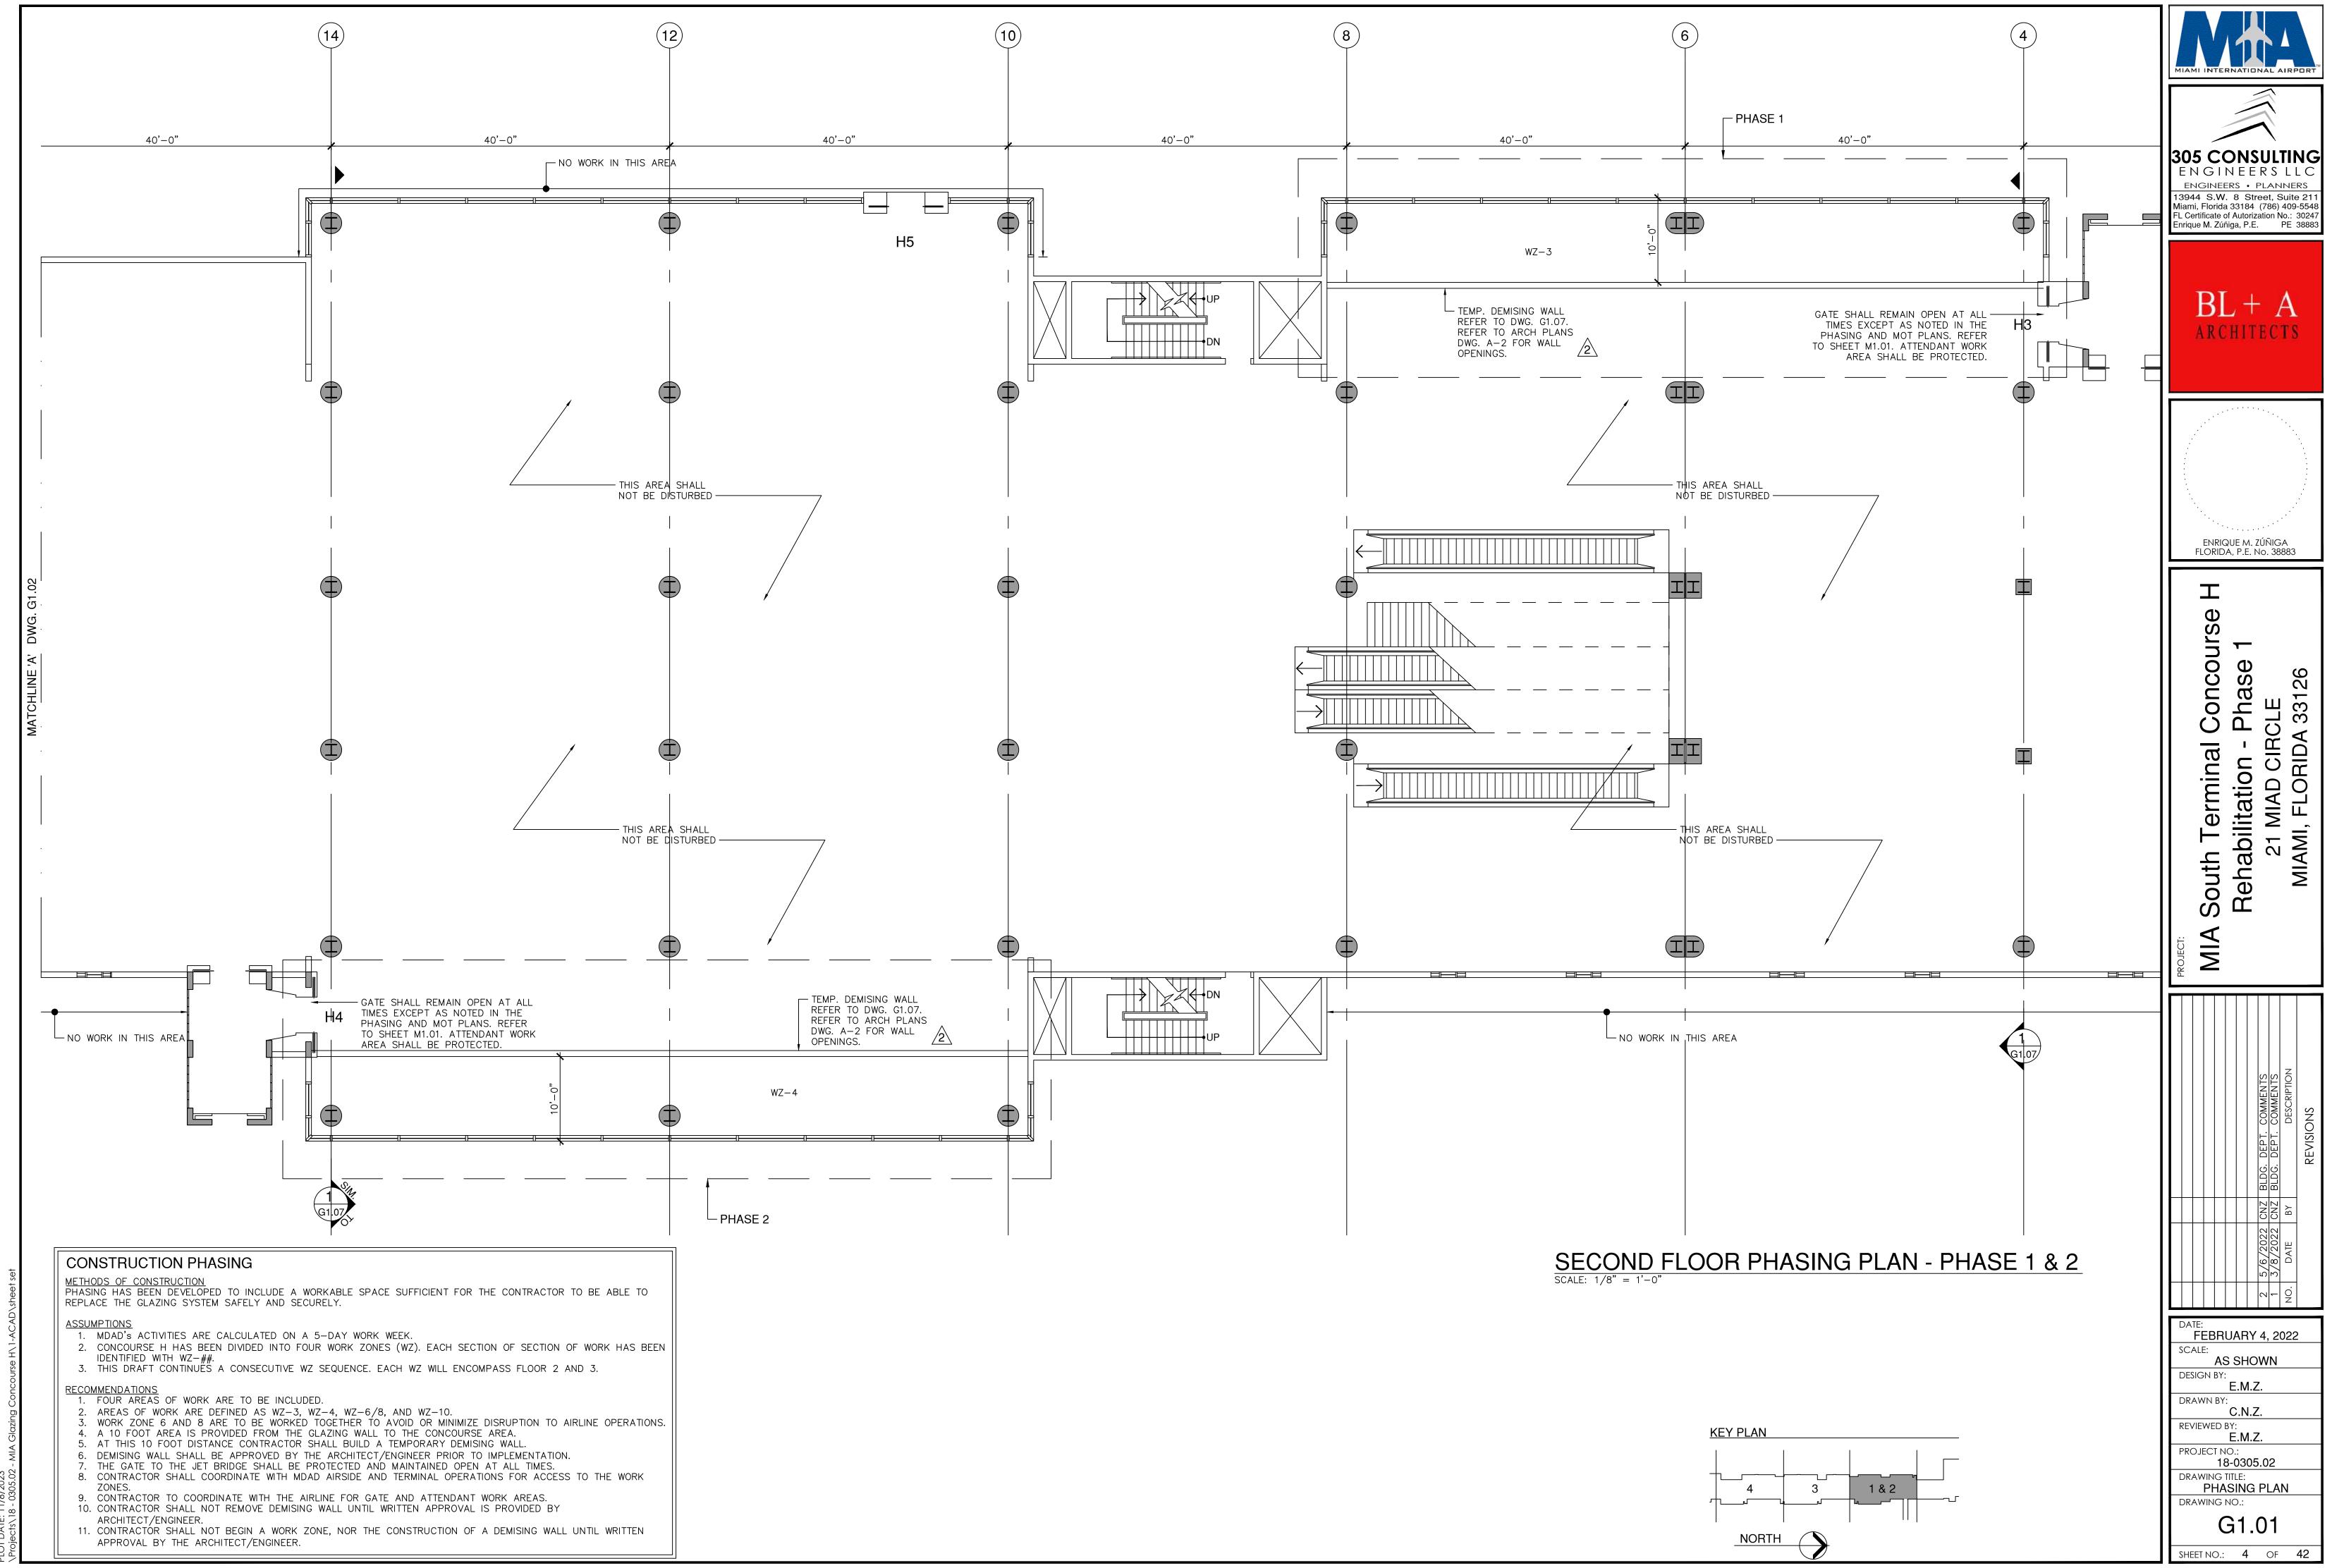

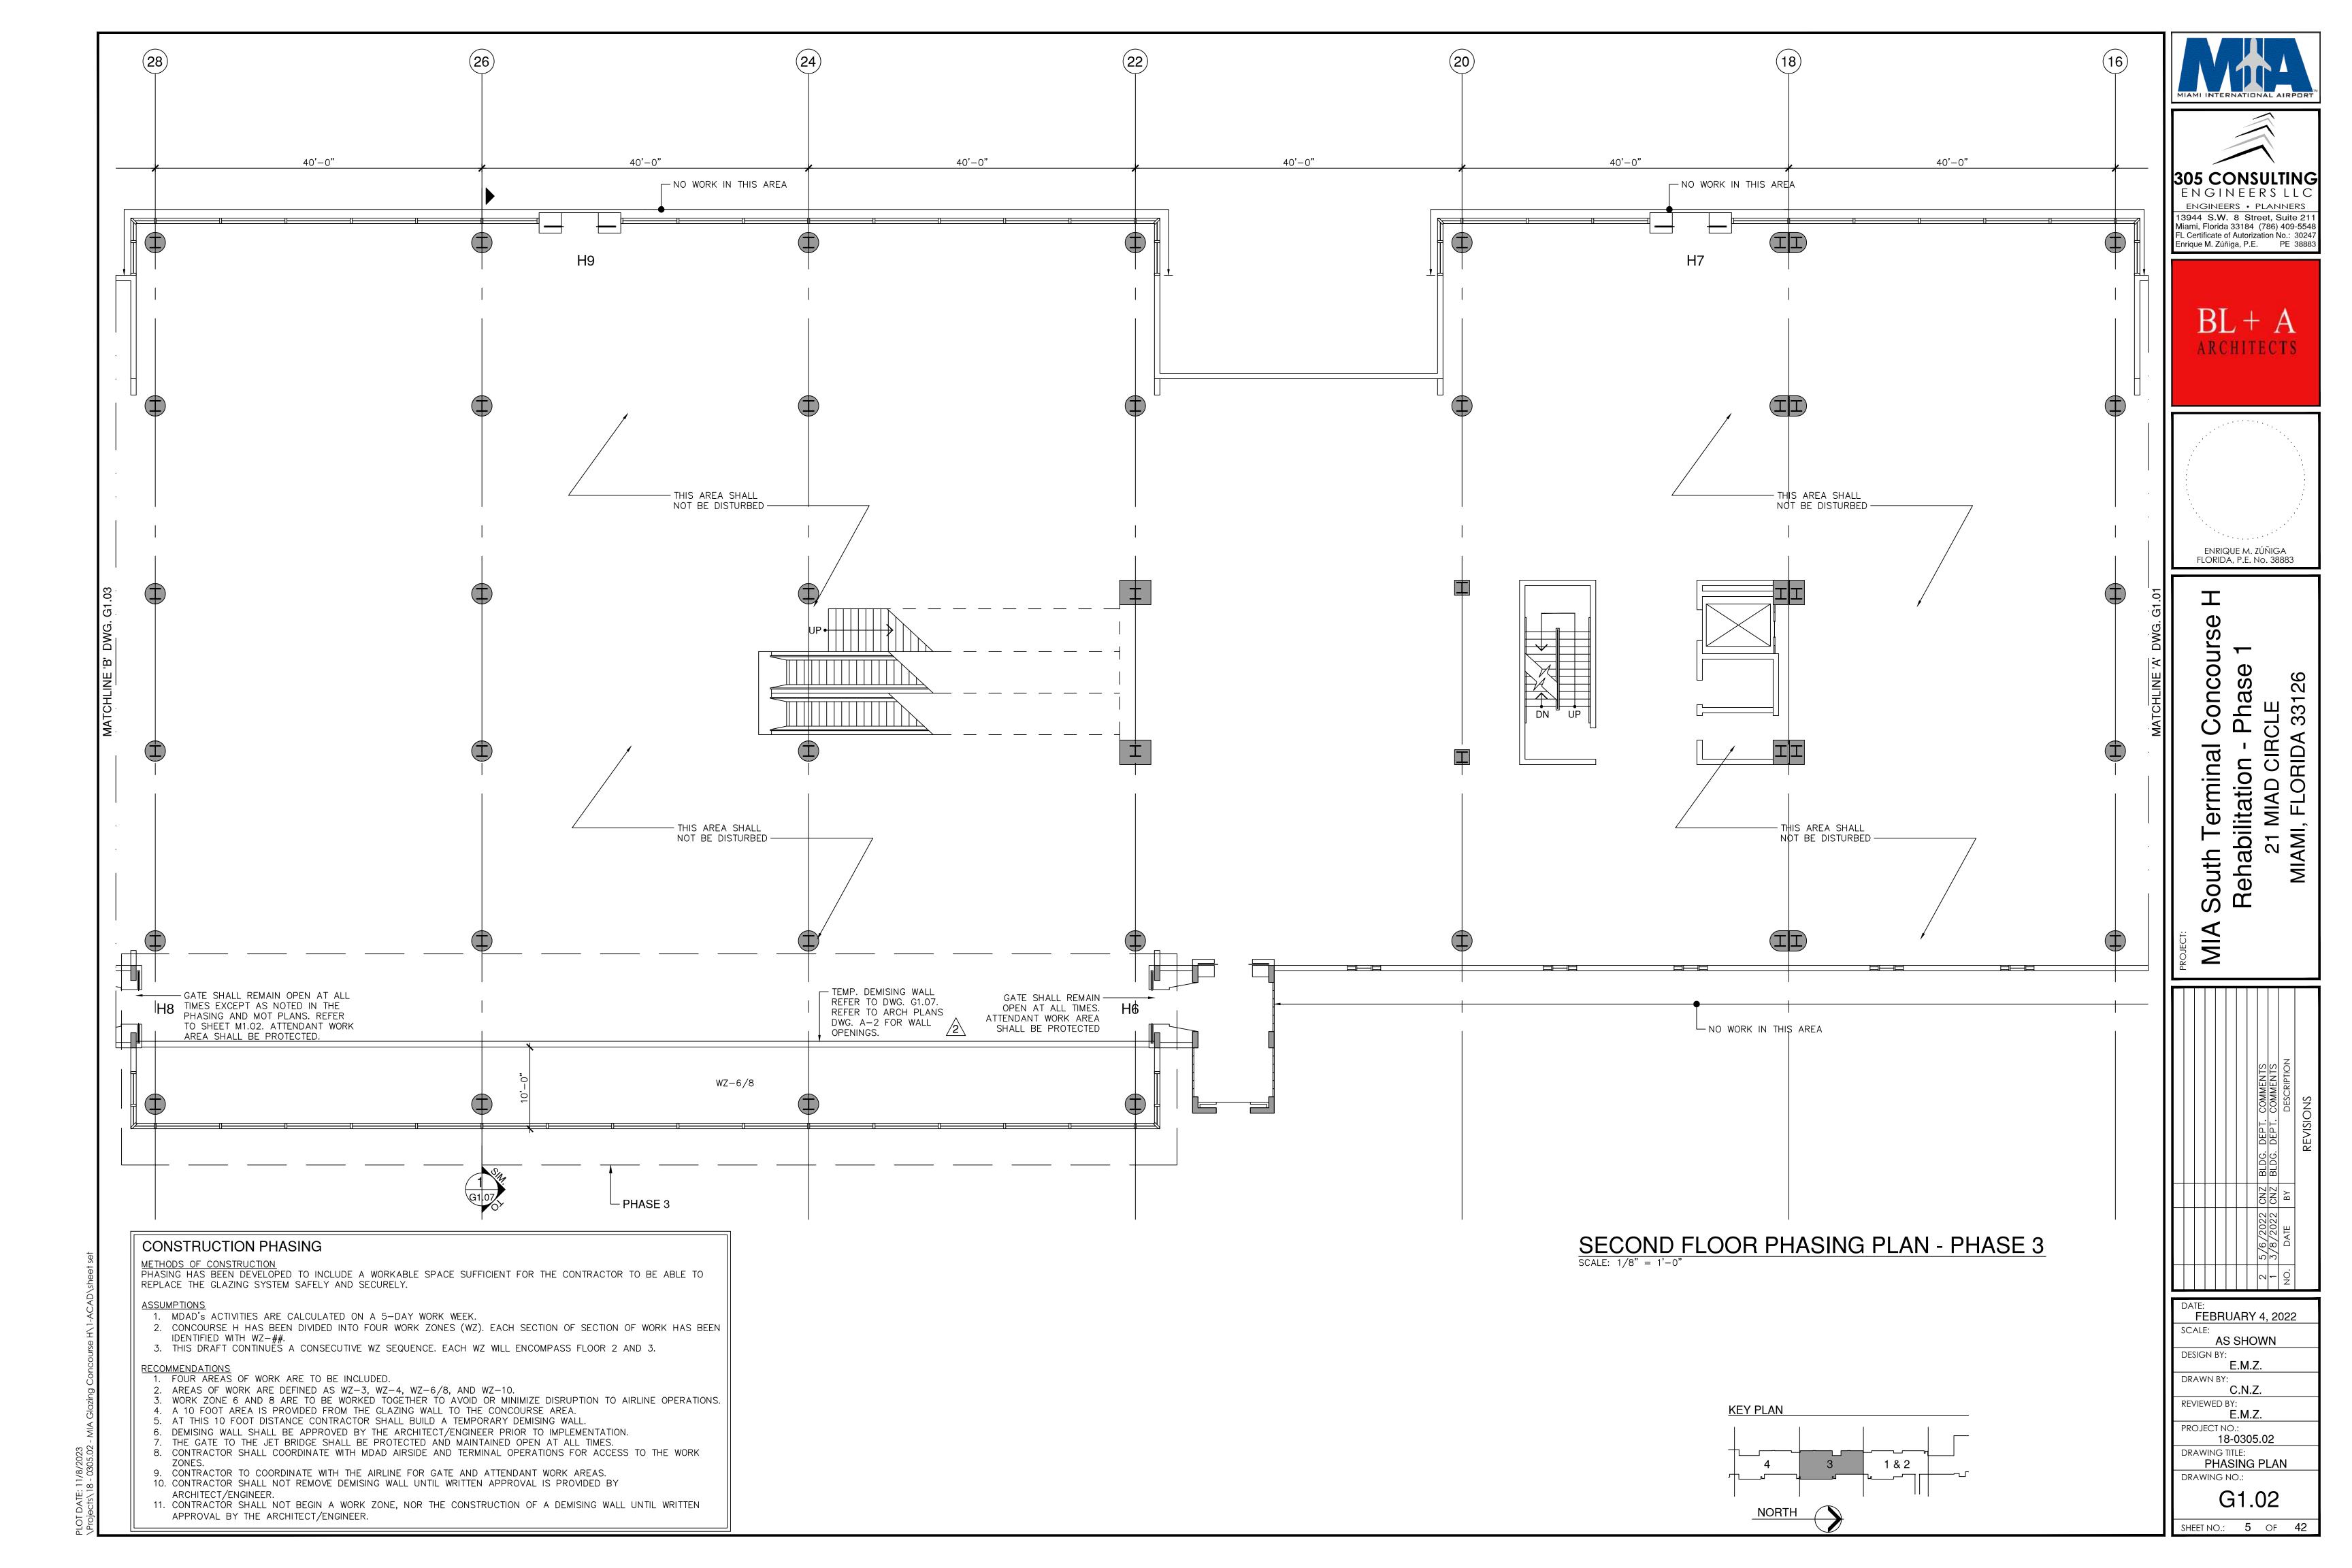


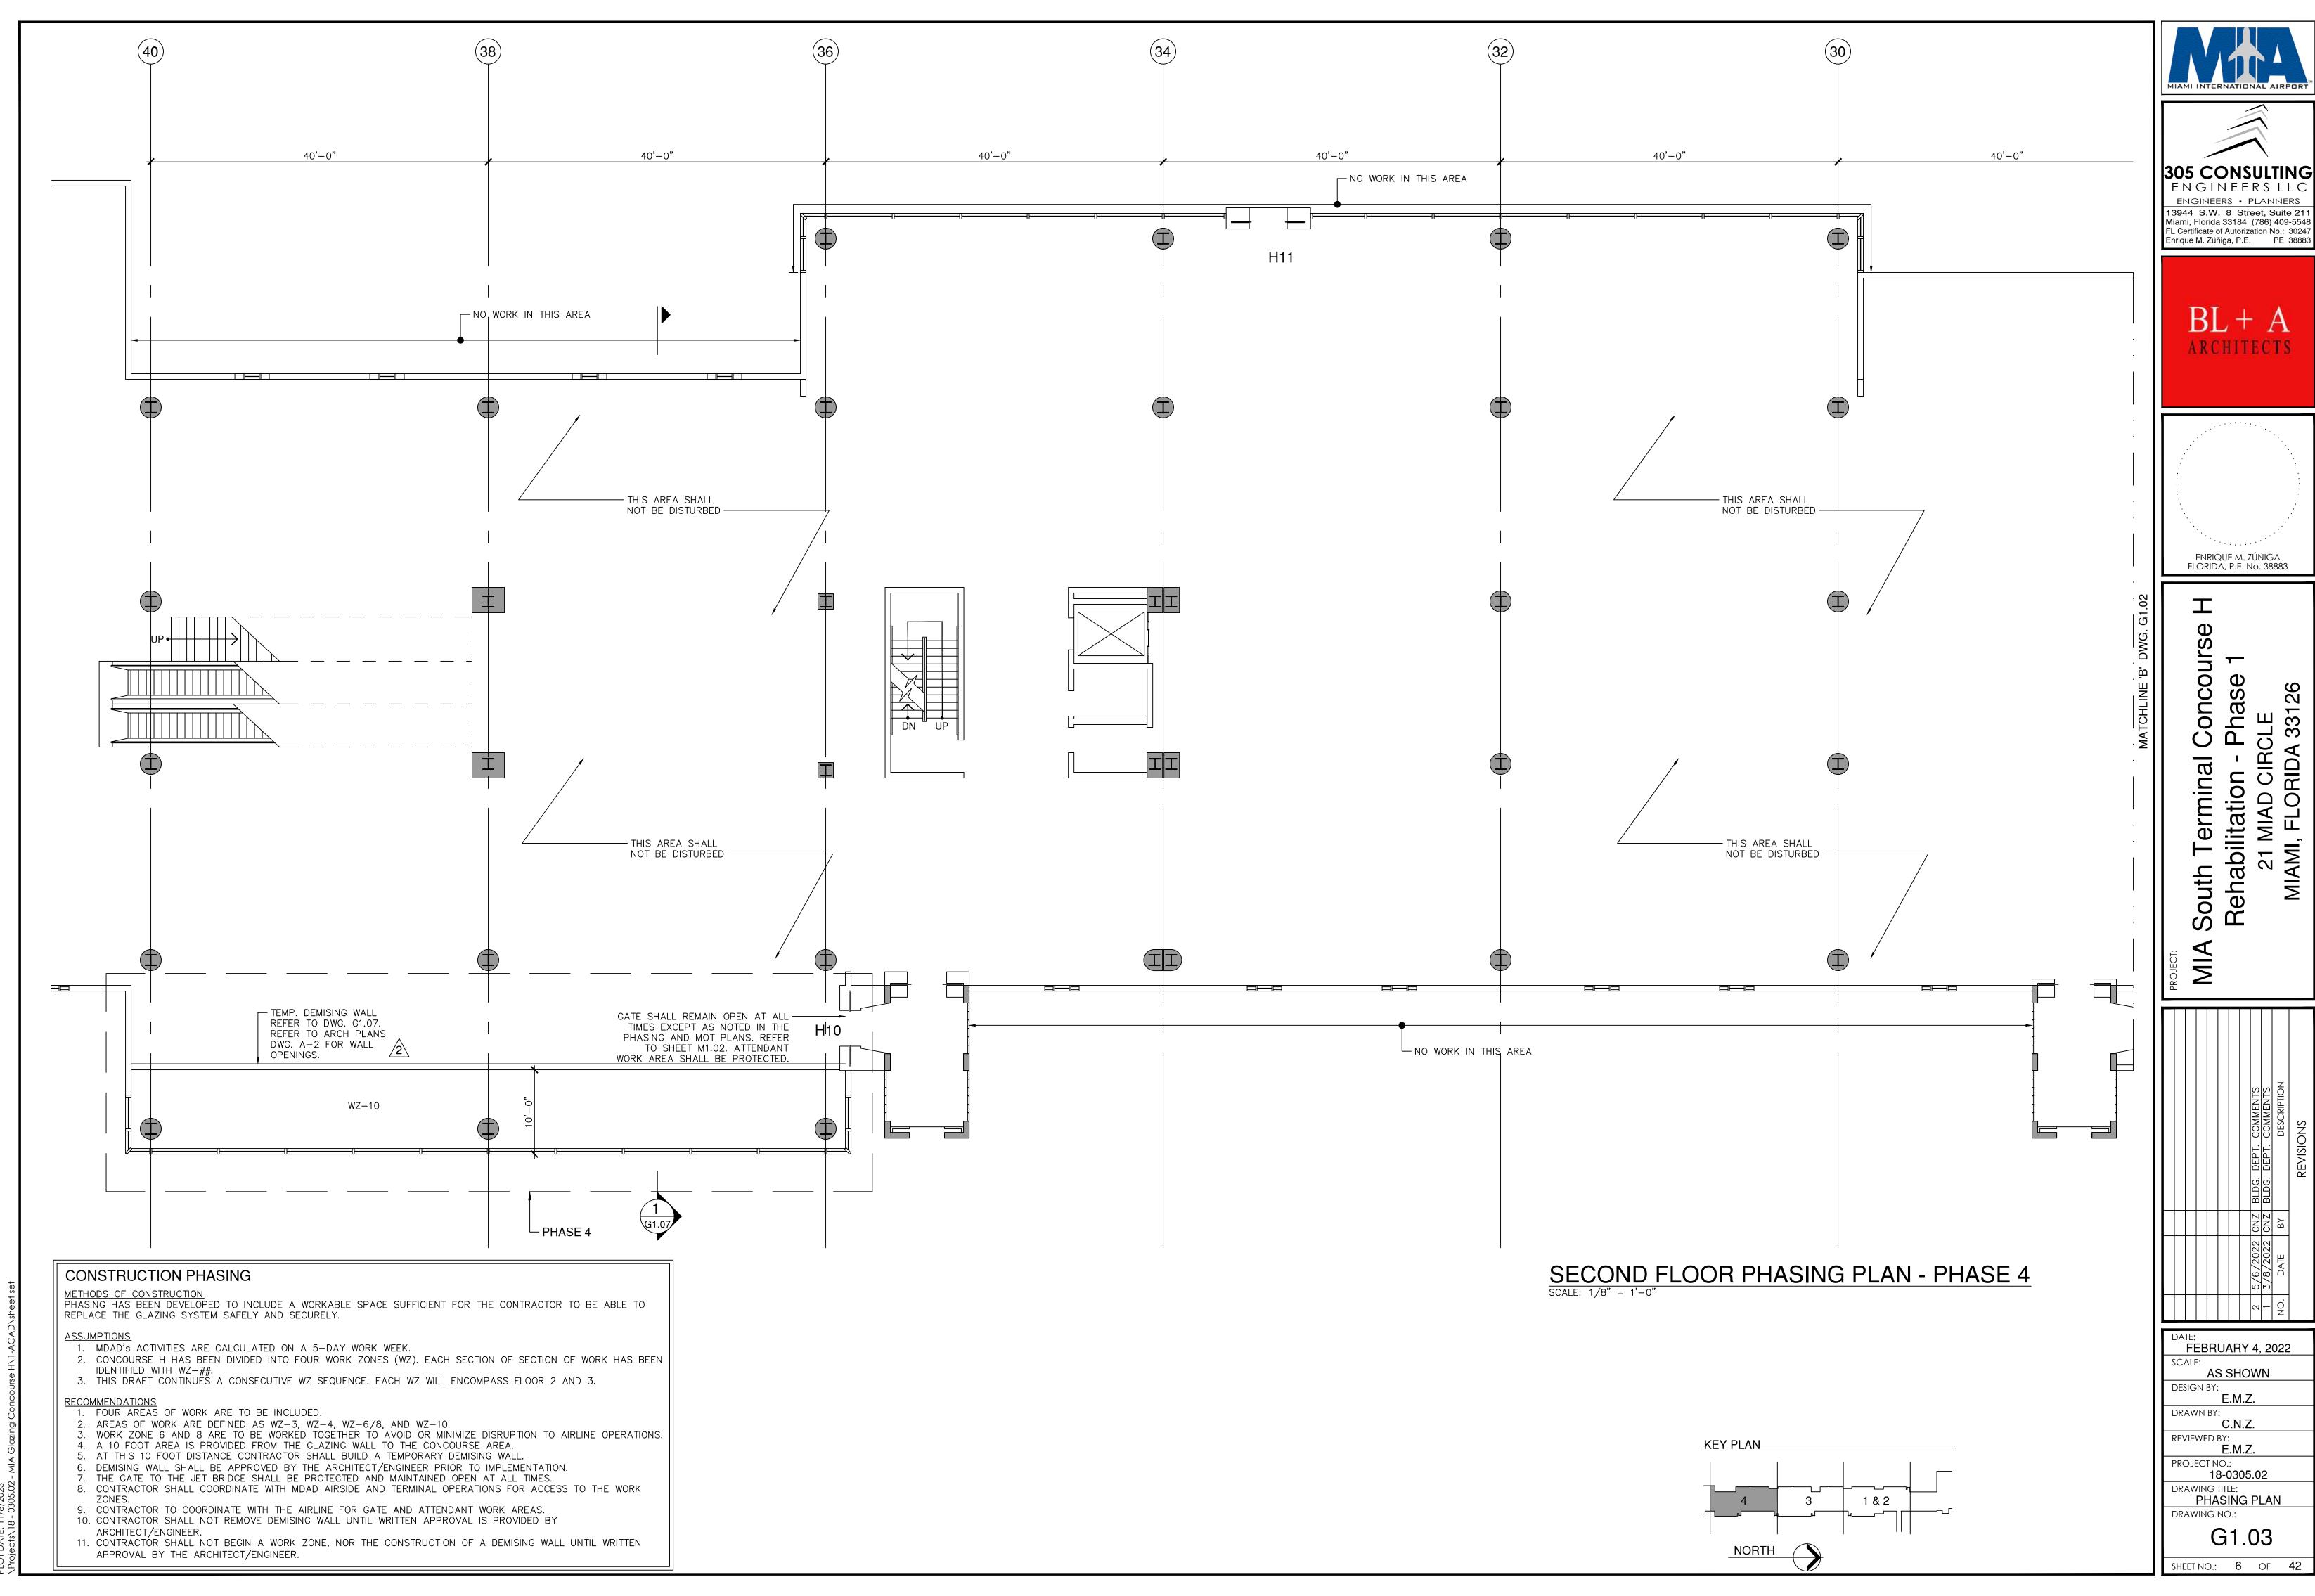DIOT DATE: 11/0/0000




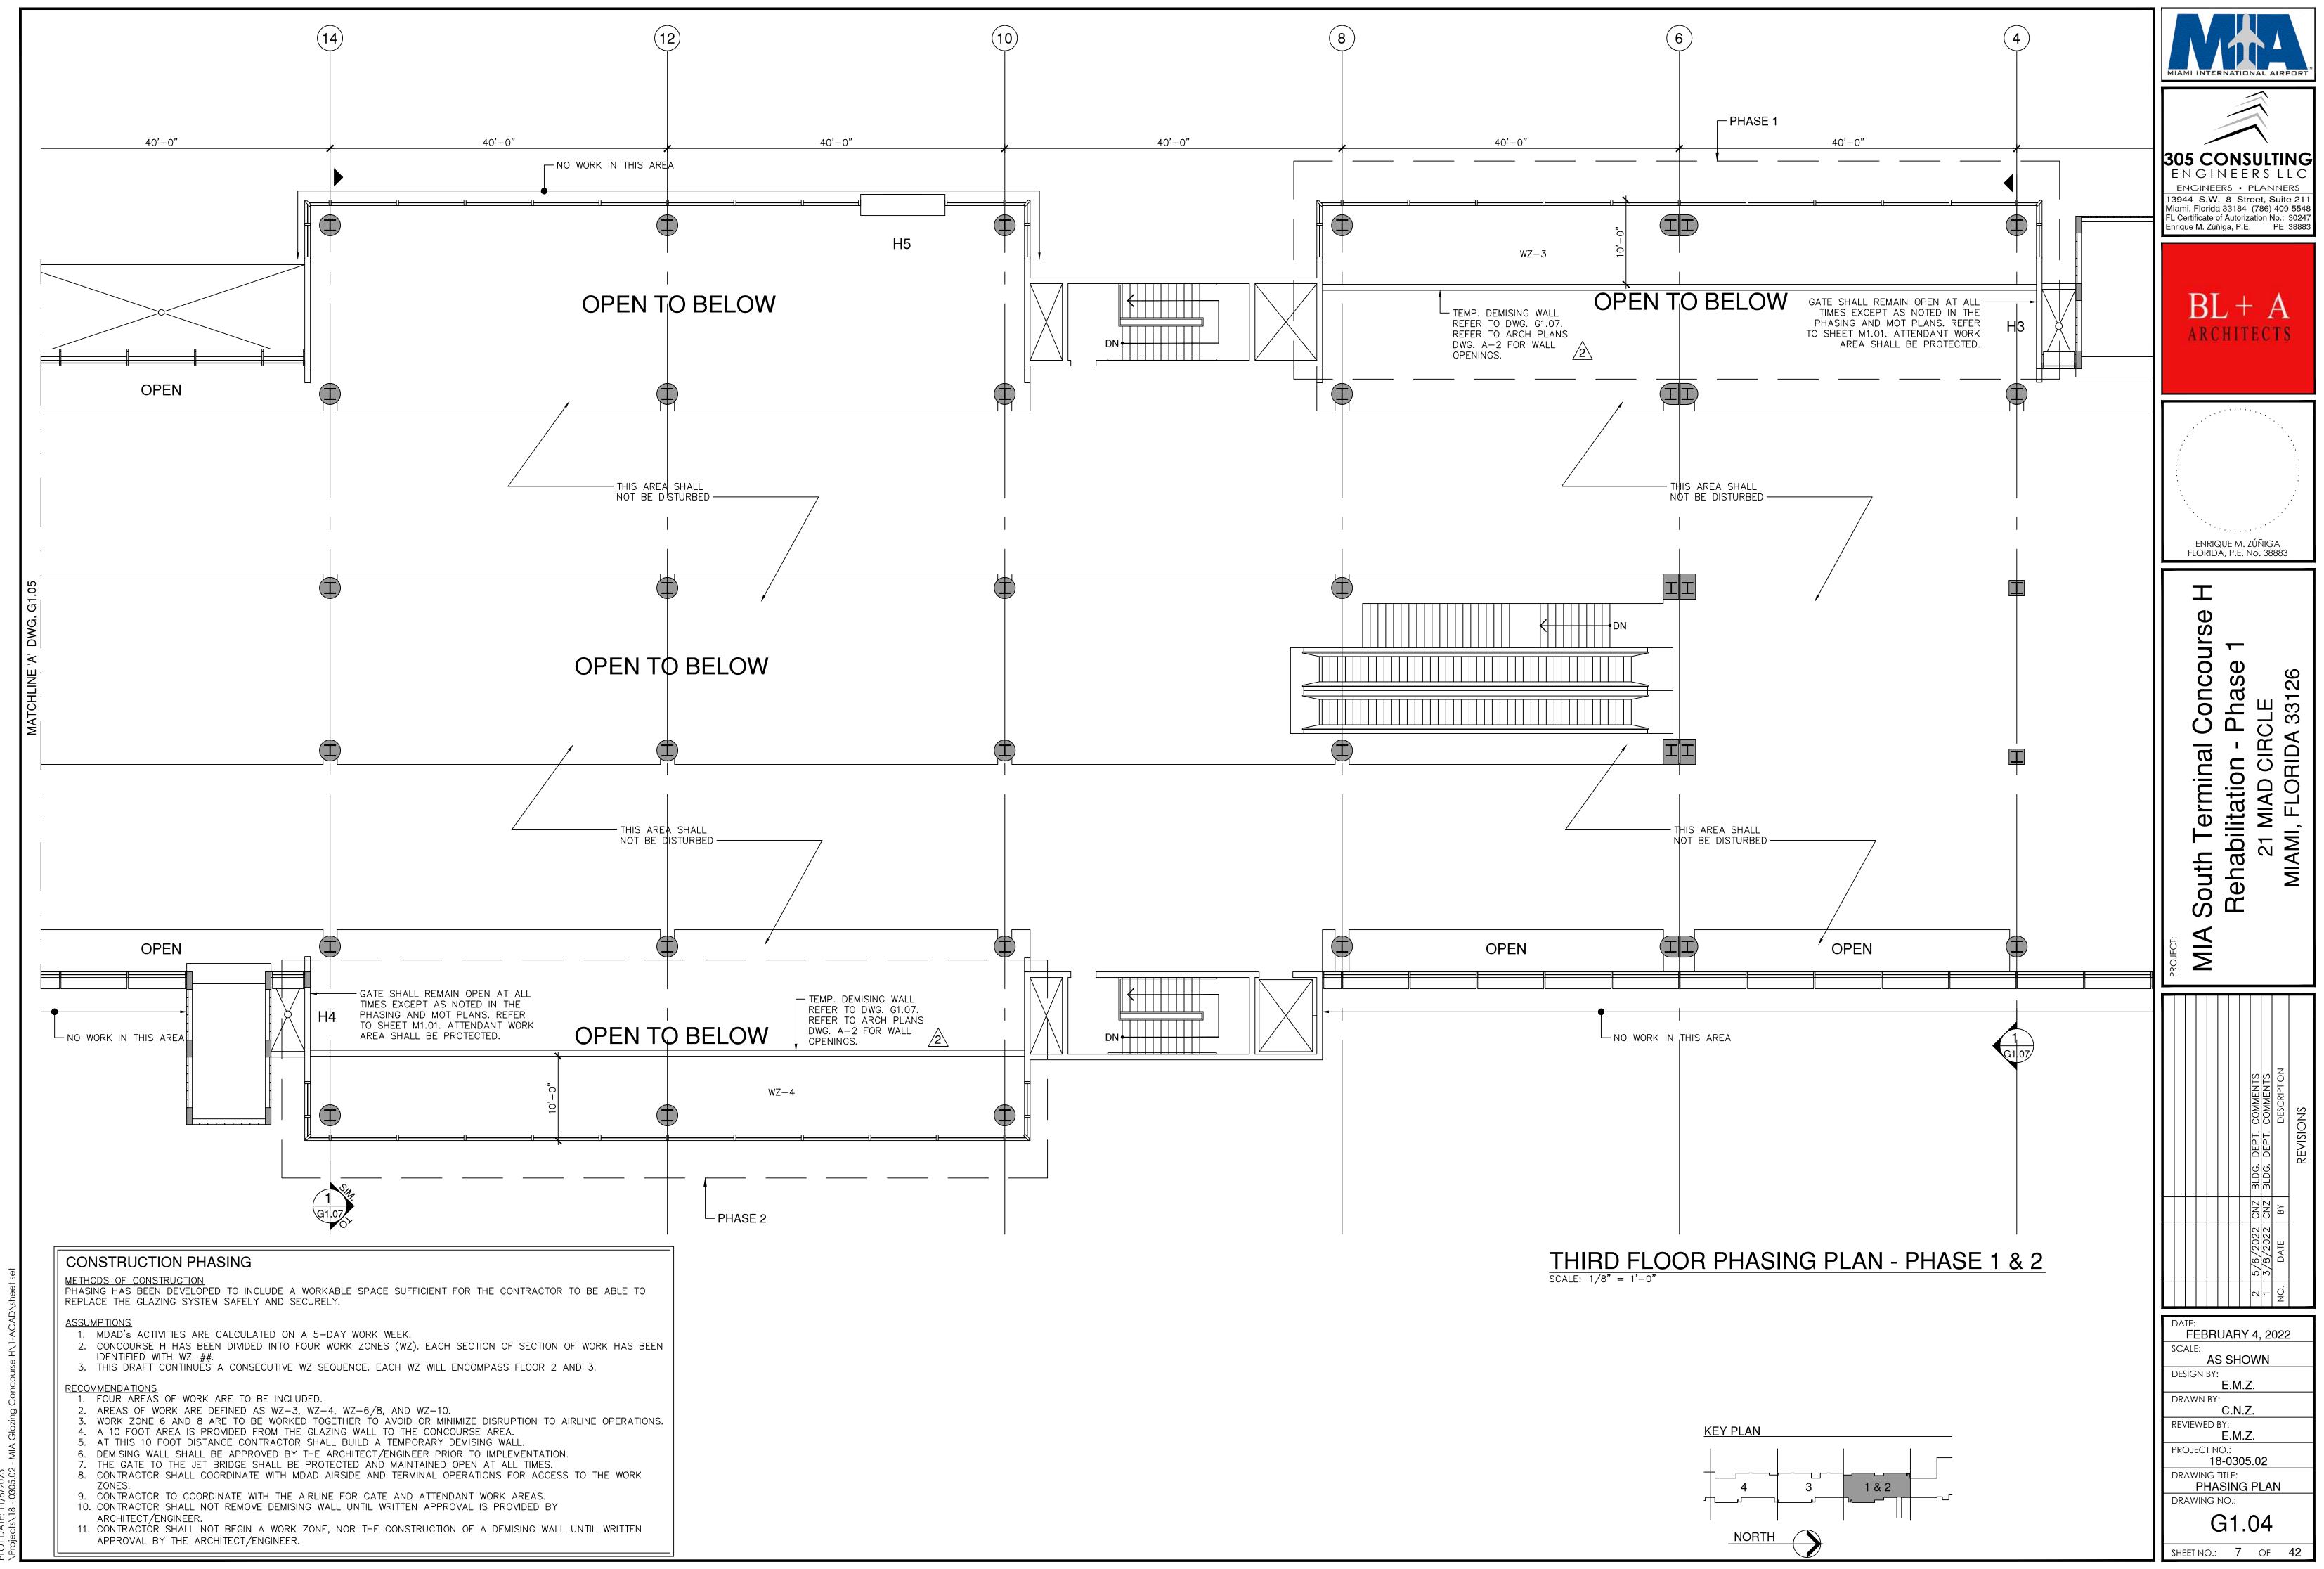

LOT DATE: 11/8/2023

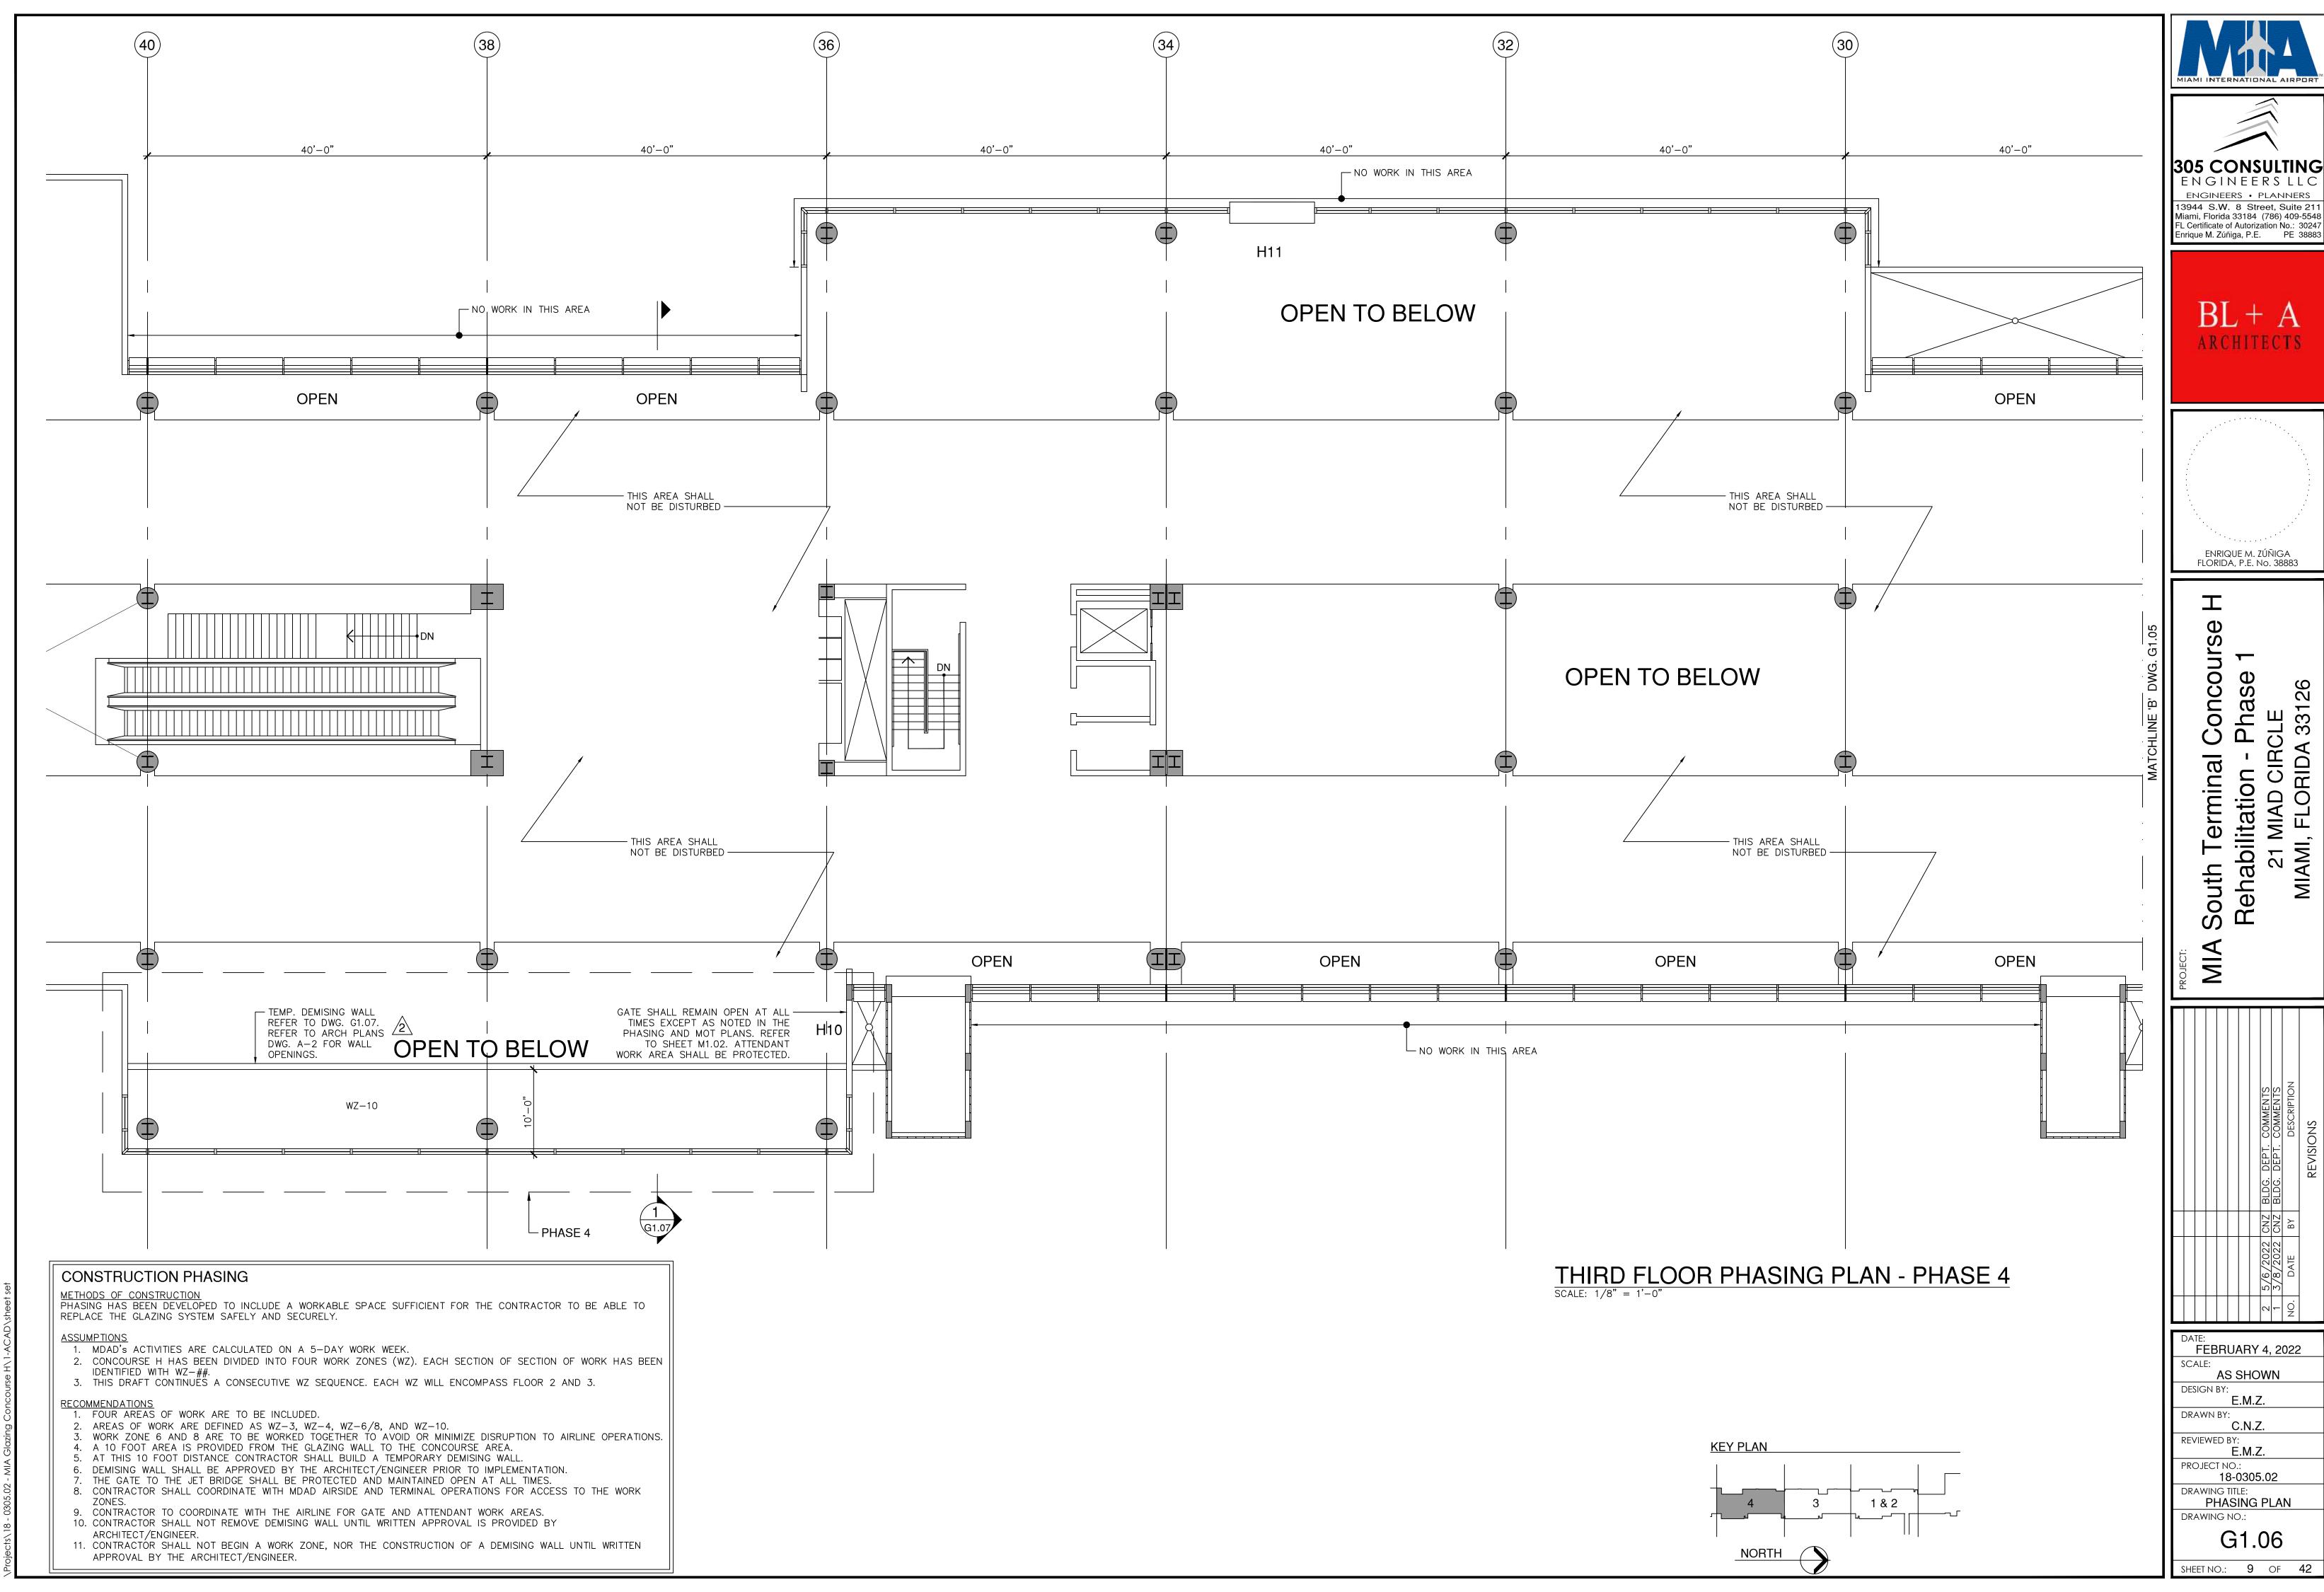


PLOT DATE: 11/8/2023

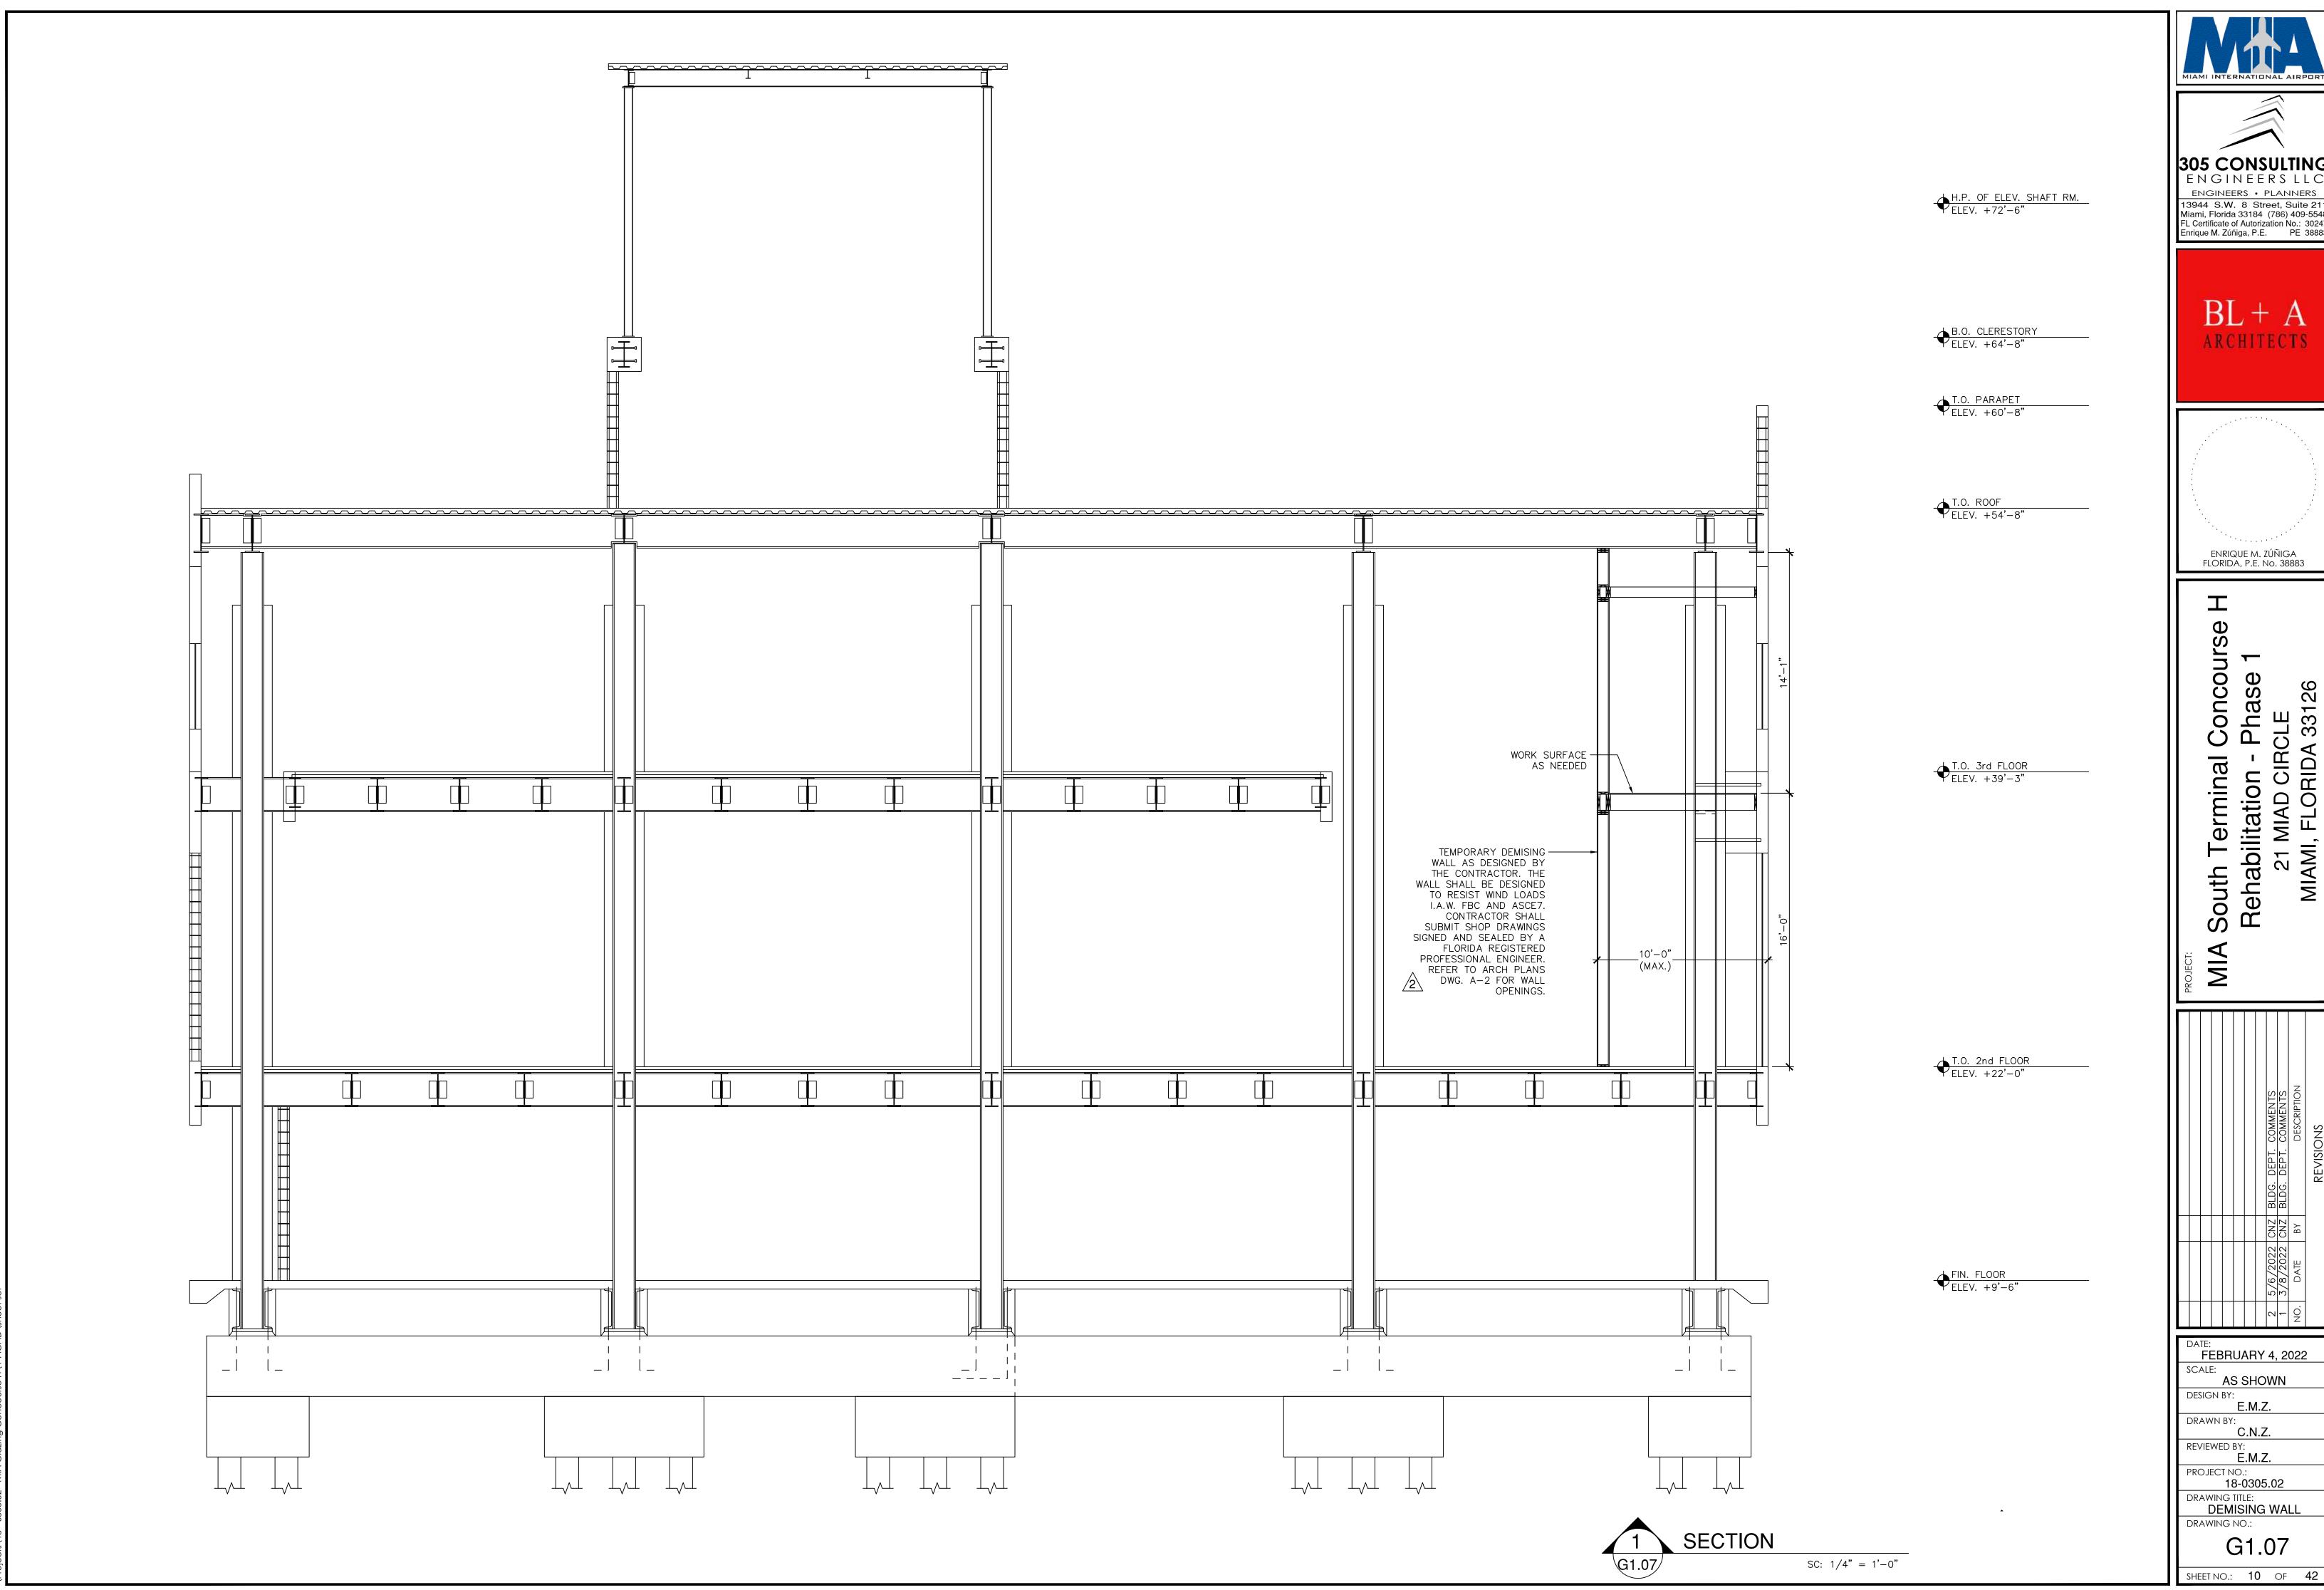

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ARCHITECTS

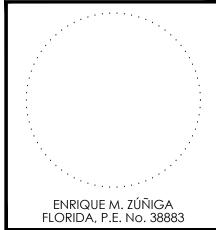

A South Terminal Concourse F Rehabilitation - Phase 1 21 MIAD CIRCLE MIAMI, FLORIDA 33126

5/6/2022 CNZ BLDG. DEPT. COMMENTS 3/8/2022 CNZ BLDG. DEPT. COMMENTS DATE BY DESCRIPTION

**FEBRUARY 4, 2022** AS SHOWN REVIEWED BY: E.M.Z.

18-0305.02 DRAWING TITLE:

DEMISING WALL

G1.07



#### SUBMITTALS:

GENERAL: SUBMIT THE FOLLOWING IN ACCORDANCE WITH CONDITIONS OF

- 1. SCHEDULE INDICATING PROPOSED SEQUENCE OF OPERATIONS FOR SELECTIVE DEMOLITION WORK TO OWNER'S REPRESENTATIVE FOR REVIEW PRIOR TO START OF WORK. INCLUDE COORDINATION FOR DUST AND NOISE CONTROL PROTECTION.
- A. PROVIDE DETAILED SEQUENCE OF DEMOLITION AND REMOVAL WORK TO ENSURE UNINTERRUPTED PROGRESS OF OWNER'S ON-SITE OPERATIONS.
- B. COORDINATE WITH OWNER'S CONTINUING OCCUPATION OF PORTIONS OF EXISTING BUILDING AND WITH OWNER'S PARTIAL OCCUPANCY OF COMPLETED NEW ADDITION.

- OCCUPANCY: PROVIDE MINIMUM OF 72 HOURS ADVANCE WRITTEN NOTICE TO OWNER OF DEMOLITION ACTIVITIES THAT WILL AFFECT OWNER'S NORMAL OPERATIONS.
- 2. PROTECTIONS: PROVIDE TEMPORARY BARRICADES AND OTHER FORMS OF PROTECTION TO PROTECT OWNER'S PERSONNEL AND GENERAL PUBLIC FROM INJURY DUE TO SELECTIVE DEMOLITION WORK.
  - A. PROVIDE INTERIOR AND EXTERIOR SHORING, BRACING, OR SUPPORT TO PREVENT MOVEMENT, SETTLEMENT, OR COLLAPSE OF STRUCTURE OR ELEMENT TO BE DEMOLISHED AND ADJACENT FACILITIES OR WORK TO REMAIN.
  - PROTECT/REPAIR/REPLACE DAMAGE TO EXISTING FINISH WORK THAT IS TO RÉMAIN IN PLACE AND BECOMES EXPOSED DURING DEMOLITION OPERATIONS, INCLUDING BUT NOT LIMITED TO WINDOW METAL ASSEMBLIES, GLASS, ACCESSORIES, ETC.
- C. PROVIDE TEMPORARY WEATHER PROTECTION DURING INTERVAL BETWEEN DEMOLITION AND REMOVAL OF EXISTING CONSTRUCTION ON EXTERIOR SURFACES & INSTALLATION OF NEW CONSTRUCTION TO ENSURE THAT NO WATER LEAKAGE OR DAMAGE OCCURS TO STRUCTURE OR INTERIOR AREAS OF EXISTING BUILDING. D. REMOVE PROTECTIONS AT COMPLETION OF WORK.
- 3. DAMAGES: PROMPTLY REPAIR DAMAGES CAUSED TO ADJACENT INTERIOR OR EXTERIOR AREAS BY DEMOLITION WORK.
- 4. TRAFFIC: CONDUCT SELECTIVE DEMOLITION OPERATIONS AND DEBRIS REMOVAL TO ENSURE MINIMUM INTERFERENCE WITH AIRSIDE OR TERMINAL OPERATIONS & OTHER ADJACENT OCCUPIED OR USED FACILITIES. DO NOT OBSTRUCT WALKS OR OTHER OCCUPIED OR USED FACILITIES WITHOUT WRITTEN PERMISSION FROM AUTHORITIES HAVING JURISDICTION.
- 5. FLAME CUTTING: PROHIBITED WITHOUT PRIOR SUBMITTAL OF A MDAD HOT WORK PERMIT AND APPROVAL BY MDAD THROUGH THE RPR. DO NOT USE CUTTING TORCHES FOR REMOVAL UNTIL WORK AREA IS CLEARED OF FLAMMABLE MATERIALS. MAINTAIN PORTABLE FIRE SUPPRESSION DEVICES DURING FLAME-CUTTING OPERATIONS.
- 6. UTILITY SERVICES: MAINTAIN EXISTING UTILITIES (M.E.P.) TO REMAIN IN SERVICE AND PROTECT THEM DURING DEMOLITION OPERATIONS. G.C. SHALL IMMEDIATELY REPAIR/REPLACE DAMAGED UTILITIES, ASSEMBLIES, EQUIPMENT, COMPONENTS, ETC. AT HIS/HER OWN EXPENSE. A. DO NOT INTERRUPT UTILITIES SERVING OCCUPIED OR USED FACILITIES, EXCEPT WHEN AUTHORIZED IN WRITING BY AUTHORITIES HAVING JURISDICTION. PROVIDE TEMPORARY SERVICES DURING
  - INTERRUPTIONS TO EXISTING UTILITIES, AS ACCEPTABLE TO GOVERNING AUTHORITIES. MAINTAIN FIRE PROTECTION SERVICES DURING SELECTIVE DEMOLITION
- GENERAL: PROVIDE INTERIOR AND EXTERIOR SHORING, BRACING, OR SUPPORT TO PREVENT MOVEMENT, SETTLEMENT, OR COLLAPSE OF AREAS TO BE DEMOLISHED AND ADJACENT FACILITIES TO REMAIN.
- A. CEASE OPERATIONS AND NOTIFY OWNER'S REPRESENTATIVE IMMEDIATELY IF SAFETY OF STRUCTURE APPEARS TO BE ENDANGERED. TAKE PRECAUTIONS TO SUPPORT STRUCTURE UNTIL DETERMINATION IS MADE FOR CONTINUING OPERATIONS.
- GENERAL: PERFORM SELECTIVE DEMOLITION WORK IN A SYSTEMATIC MANNER. USE SUCH METHODS AS REQUIRED TO COMPLETE WORK INDICATED ON DRAWINGS IN ACCORDANCE WITH DEMOLITION SCHEDULE AND GOVERNING REGULATIONS.
- A. LOCATE DEMOLITION EQUIPMENT THROUGHOUT STRUCTURE & PROMPTLY REMOVE DEBRIS TO AVOID IMPOSING EXCESSIVE LOADS ON SUPPORTING WALLS, FLOORS, OR FRAMING.
- PROVIDE SERVICES FOR EFFECTIVE AIR AND WATER POLLUTION CONTROLS AS REQUIRED BY LOCAL AUTHORITIES HAVING JURISDICTION.
- 2. IF UNANTICIPATED MECHANICAL, ELECTRICAL, OR STRUCTURAL ELEMENTS THAT CONFLICT WITH INTENDED FUNCTION OR DESIGN ARE ENCOUNTERED, INVESTIGATE AND MEASURE BOTH NATURE AND EXTENT OF THE CONFLICT. SUBMIT REPORT TO OWNER'S REPRESENTATIVE IN WRITTEN, ACCURATE DETAIL. PENDING RECEIPT OF DIRECTIVE FROM OWNER'S REPRESENTATIVE, REARRANGE SELECTIVE DEMOLITION SCHEDULE AS NECESSARY TO CONTINUE OVERALL JOB PROGRESS WITHOUT UNDUE

#### DISPOSAL OF DEMOLISHED MATERIALS

GENERAL: DAILY REMOVAL AND DISPOSAL FROM BUILDING MATERIALS RESULTING FROM DEMOLITION OPERATIONS. TRANSPORT AND LEGALLY

- A. IF HAZARDOUS MATERIALS ARE ENCOUNTERED DURING DEMOLITION OPERATIONS, COMPLY WITH APPLICABLE REGULATIONS, LAWS, AND ORDINANCES CONCERNING REMOVAL, HANDLING, AND PROTECTION
- AGAINST EXPOSURE OR ENVIRONMENTAL POLLUTION. B. BURNING OF REMOVED MATERIALS IS NOT PERMITTED ON PROJECT

#### CLEANUP/DAMAGES AND REPAIR

GENERAL: DURING DEMOLITION WORK, G.C./GLAZING/CURTAIN WALL CONTRACTOR SHALL REMOVE TOOLS, EQUIPMENT, AND DEMOLISHED MATERIALS FROM SITE. REMOVE PROTECTIONS AND LEAVE AREAS BROOM CLEAN.

REPAIR DEMOLITION PERFORMED IN EXCESS OF THAT REQUIRED. RETURN ELEMENTS OF CONSTRUCTION AND SURFACES TO REMAIN TO CONDITION EXISTING PRIOR TO START OPERATIONS. REPAIR ADJACENT CONSTRUCTION OR WORK. SURFACES SOILED OR DAMAGED BY SELECTIVE DEMOLITION.

#### CODE COMPLIANCE

ALL DEMOLITIONS SHALL COMPLY WITH FLORIDA BUILDING CODE 2020 CHAPTER 34-EXISTING BUILDING AND STRUCTURE.

#### ASBESTOS CONTAINING MATERIALS NOTE:

ALL REMOVAL OF CATEGORY I ASBESTOS CONTAINING MATERIALS SHALL BE DONE BY A FLORIDA LICENSED ASBESTOS ABATEMENT CONTRACTOR UTILIZING PROPER ABATEMENT PROCEDURES PER OSHA 29 CRF PART 1926.1101, AND DOCUMENTARY AIR MONITORING TO VERIFY COMPLIANCE WITH EPA NESHAPS 40 CFR PART 61, SUBSTRACT M. G.C. SHALL REFERENCE ASBESTOR SURVEY REPORT PREPARED BY PROFESSIONAL SERVICE INDUSTRIES, INC. DATED MAY 09, 2005 (PSI PROJECT NUMBER 691-5E031.002) FOR ASBESTOS CONTAINING

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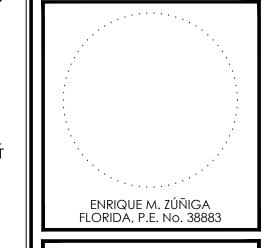
SHEET NO.: 11 OF 42

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ARCHITECTS

FL Certificate of Autorization No.: 30247

Enrique M. Zúñiga, P.E. PE 38883



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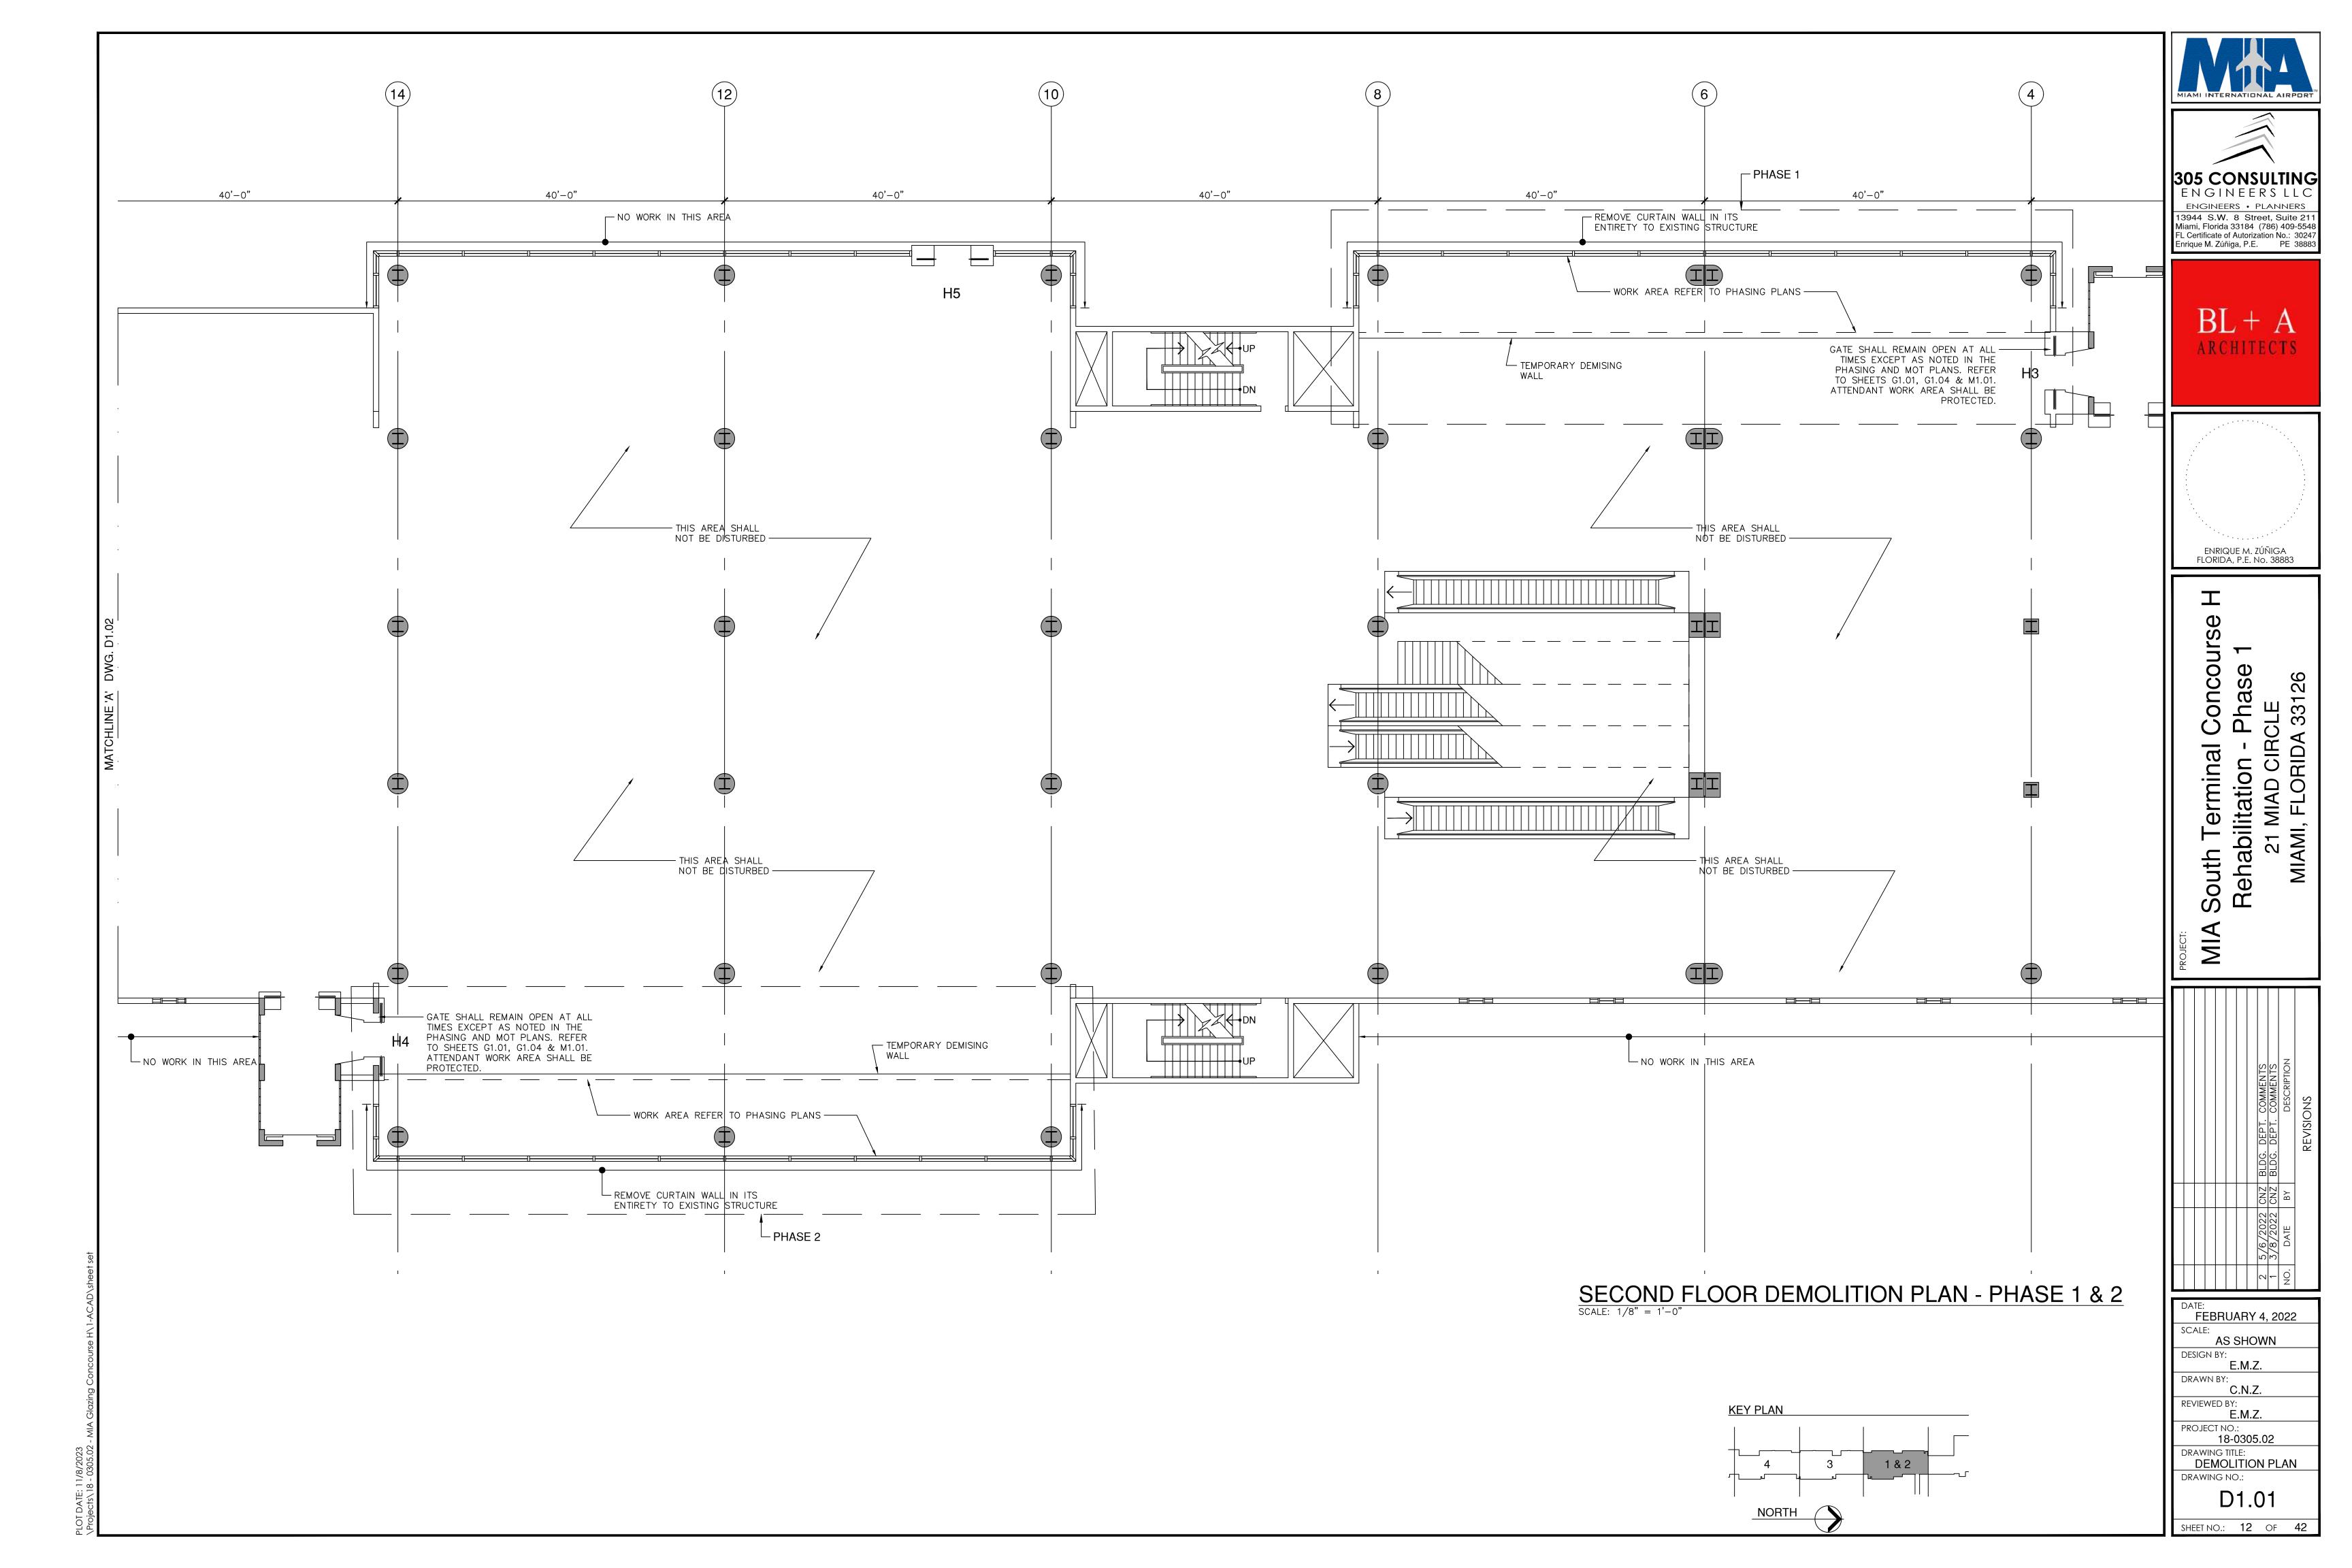
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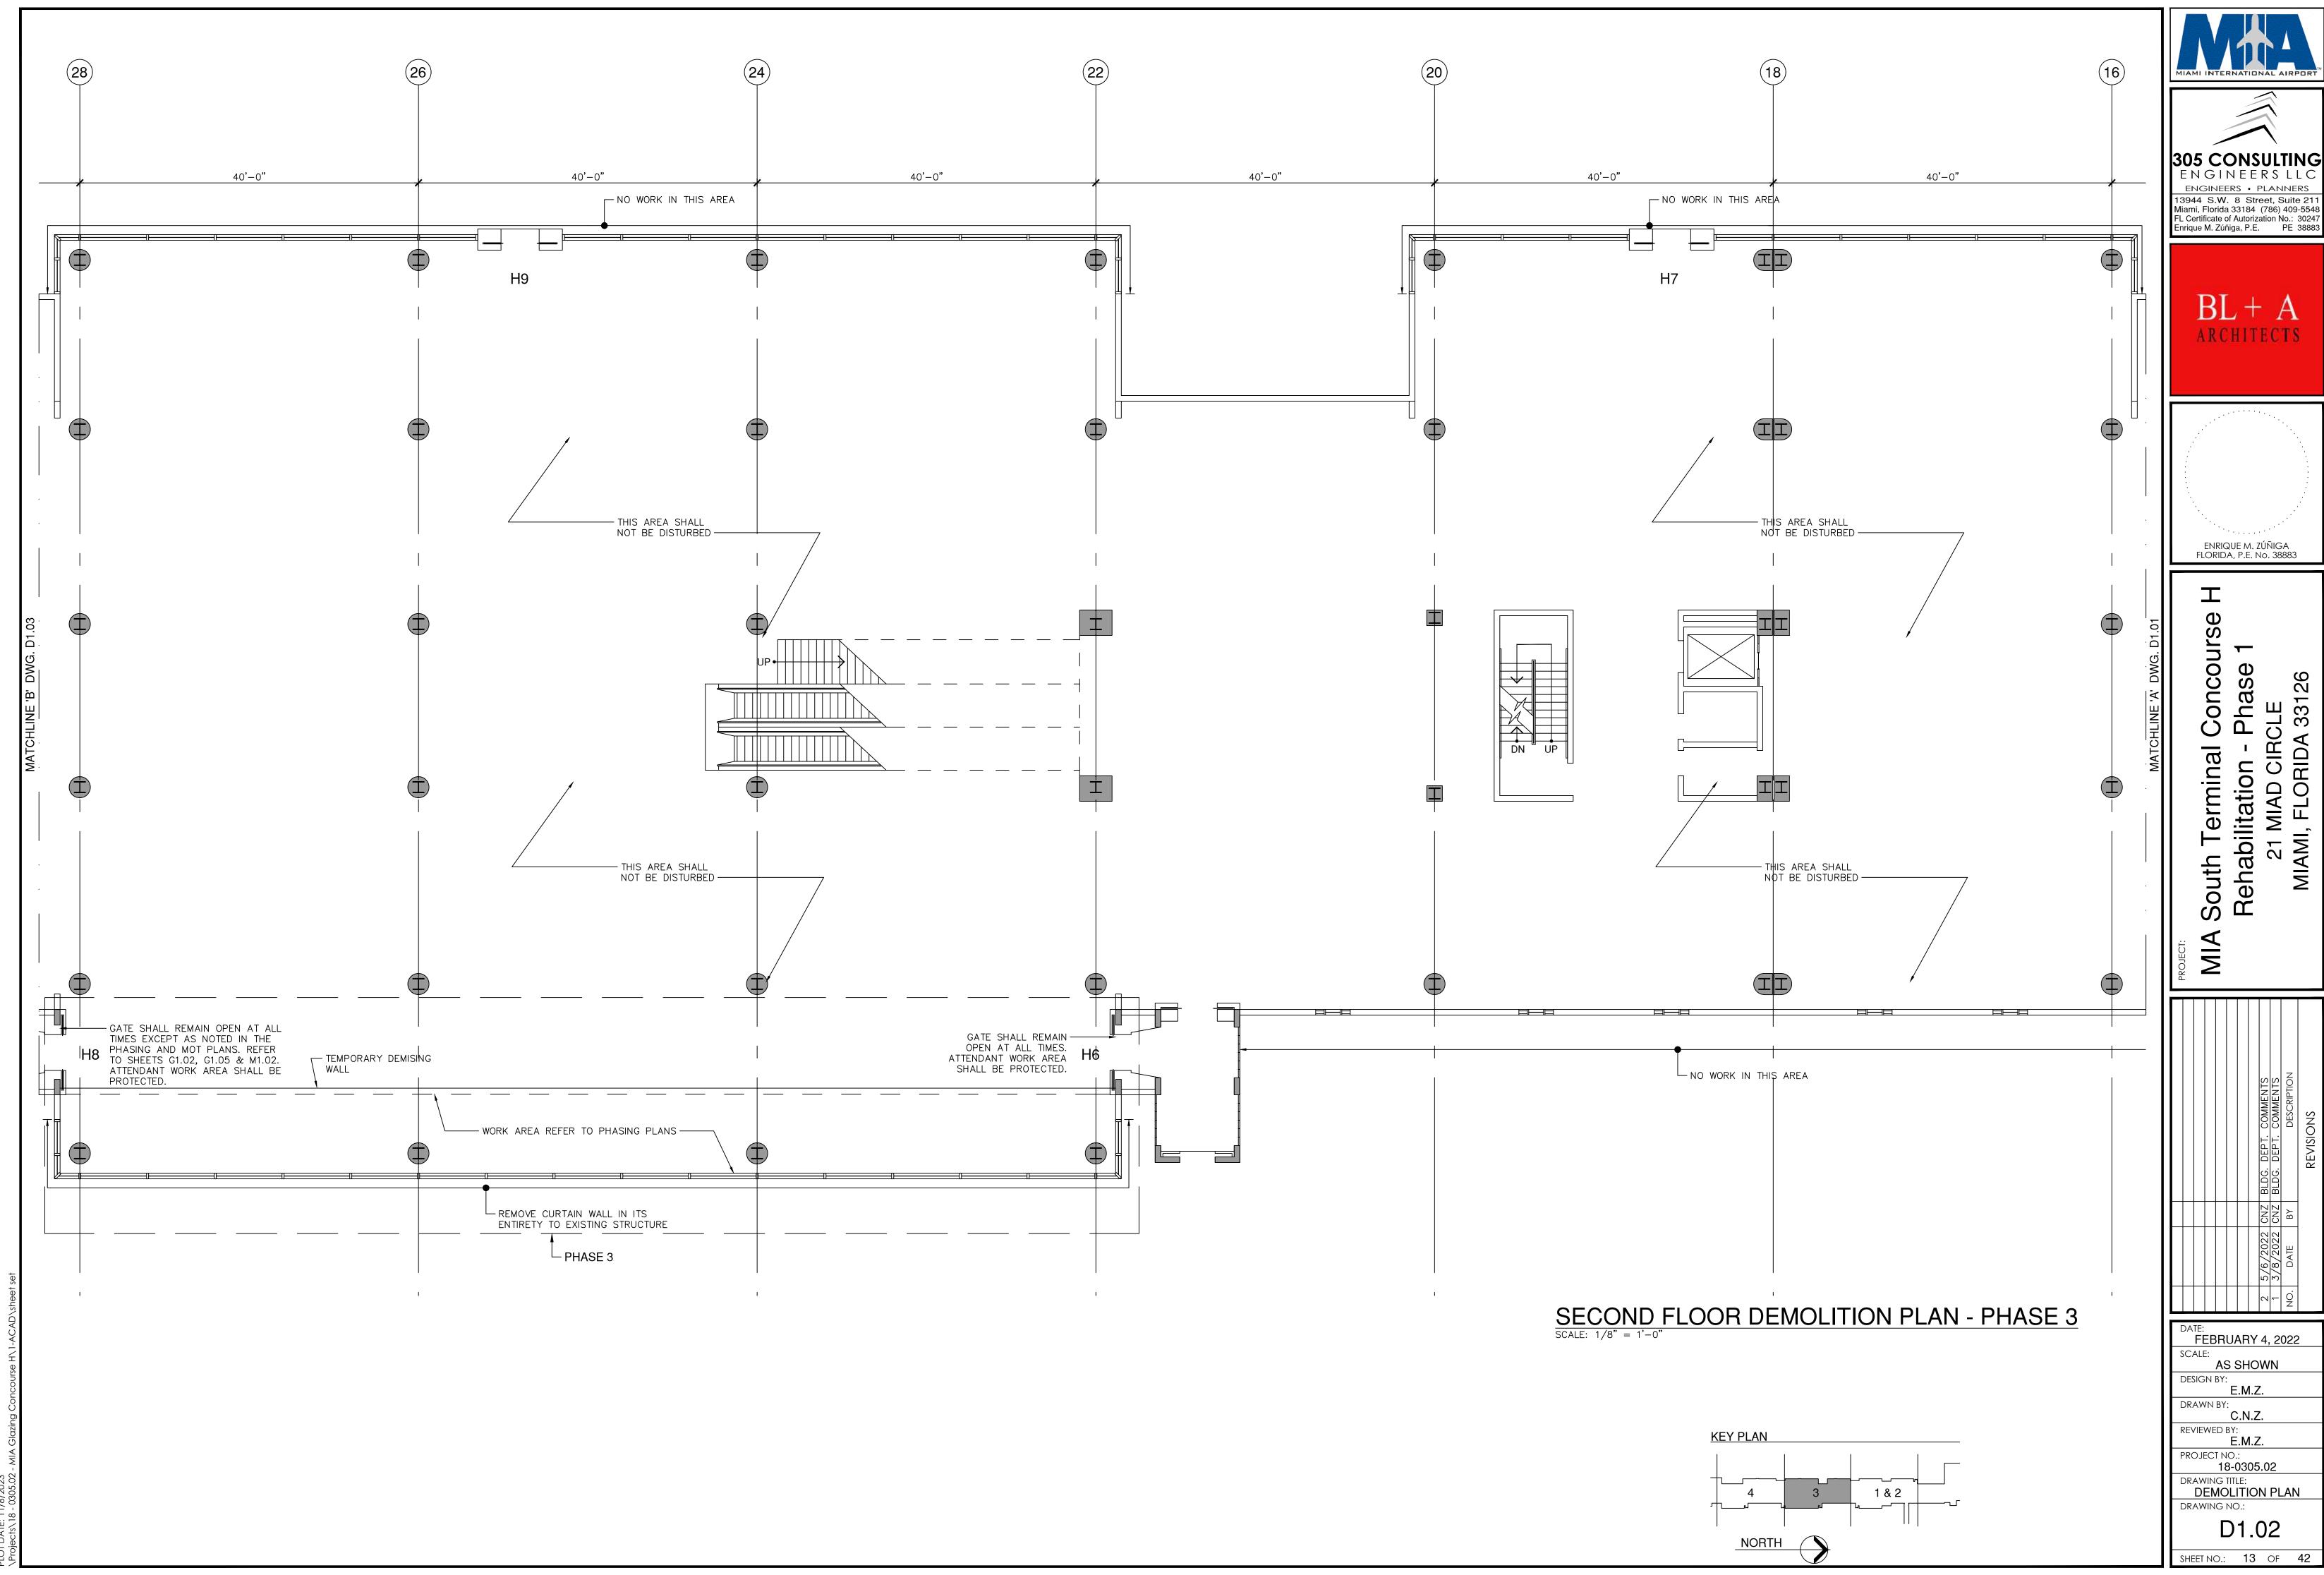
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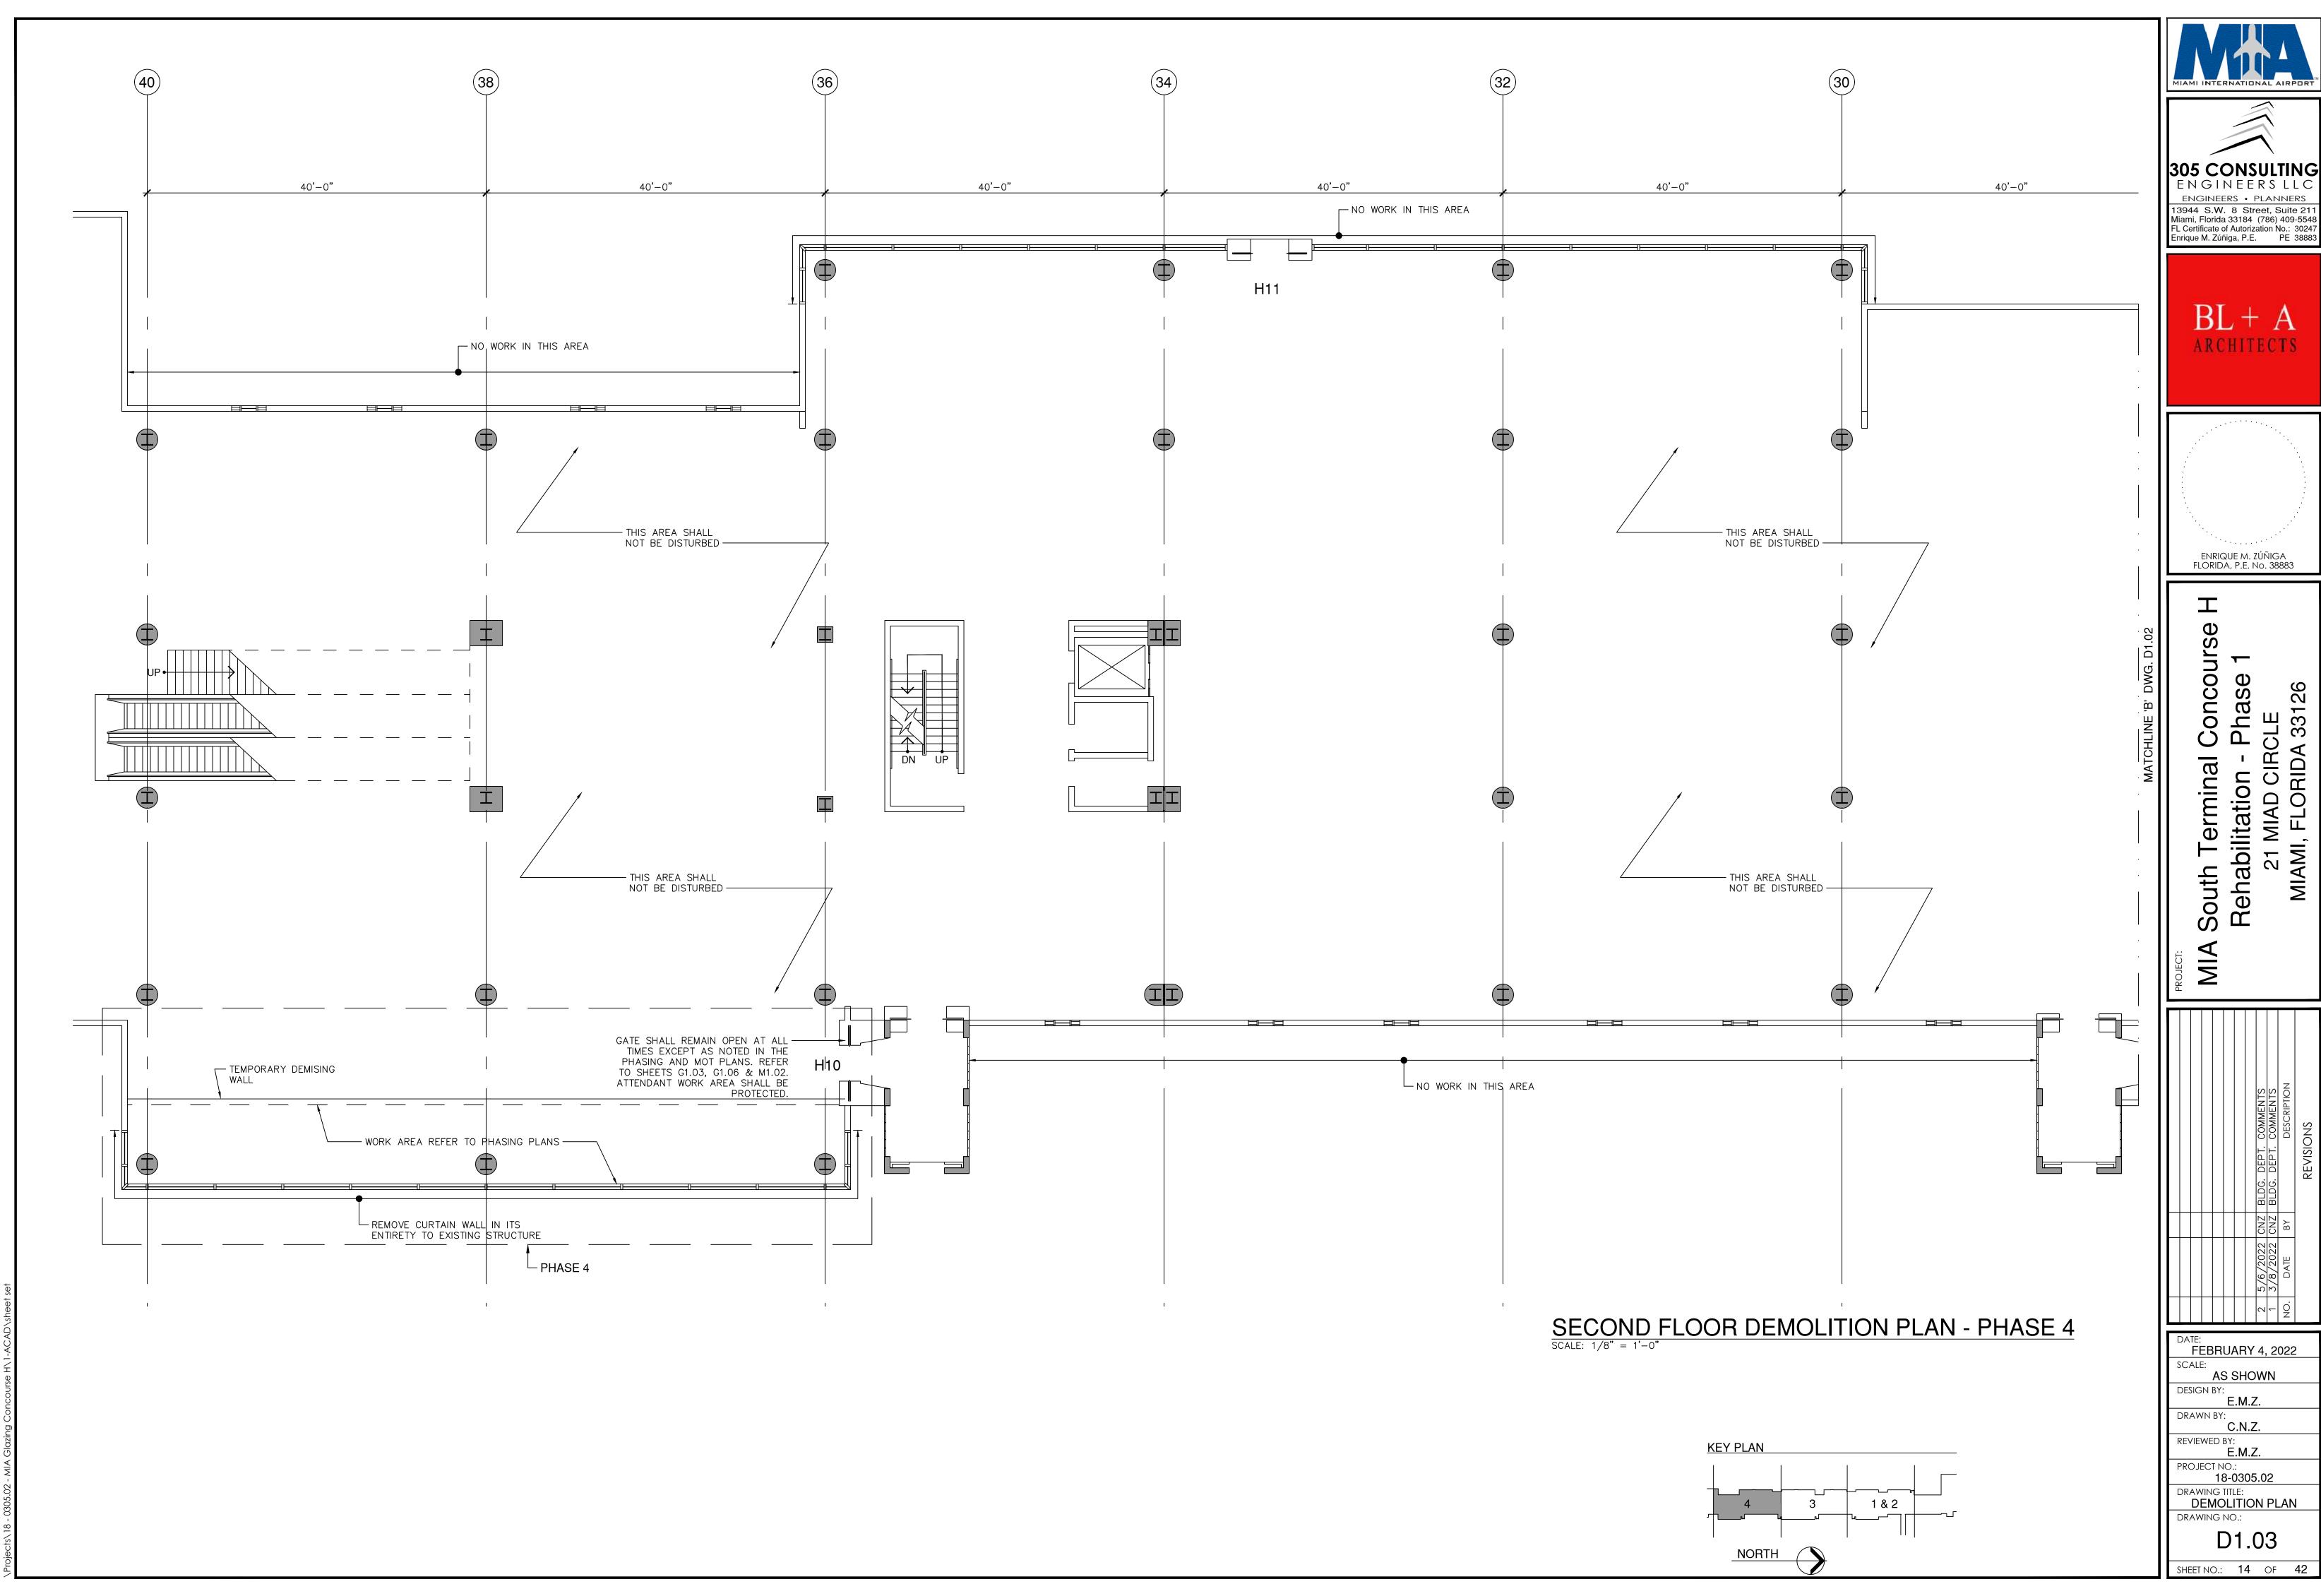
FEBRUARY 4, 2022 SCALE: AS SHOWN DESIGN BY: DRAWN BY:

C.N.Z. REVIEWED BY: E.M.Z. PROJECT NO.: 18-0305.02

DRAWING TITLE: DEMOLITION NOTES DRAWING NO .:











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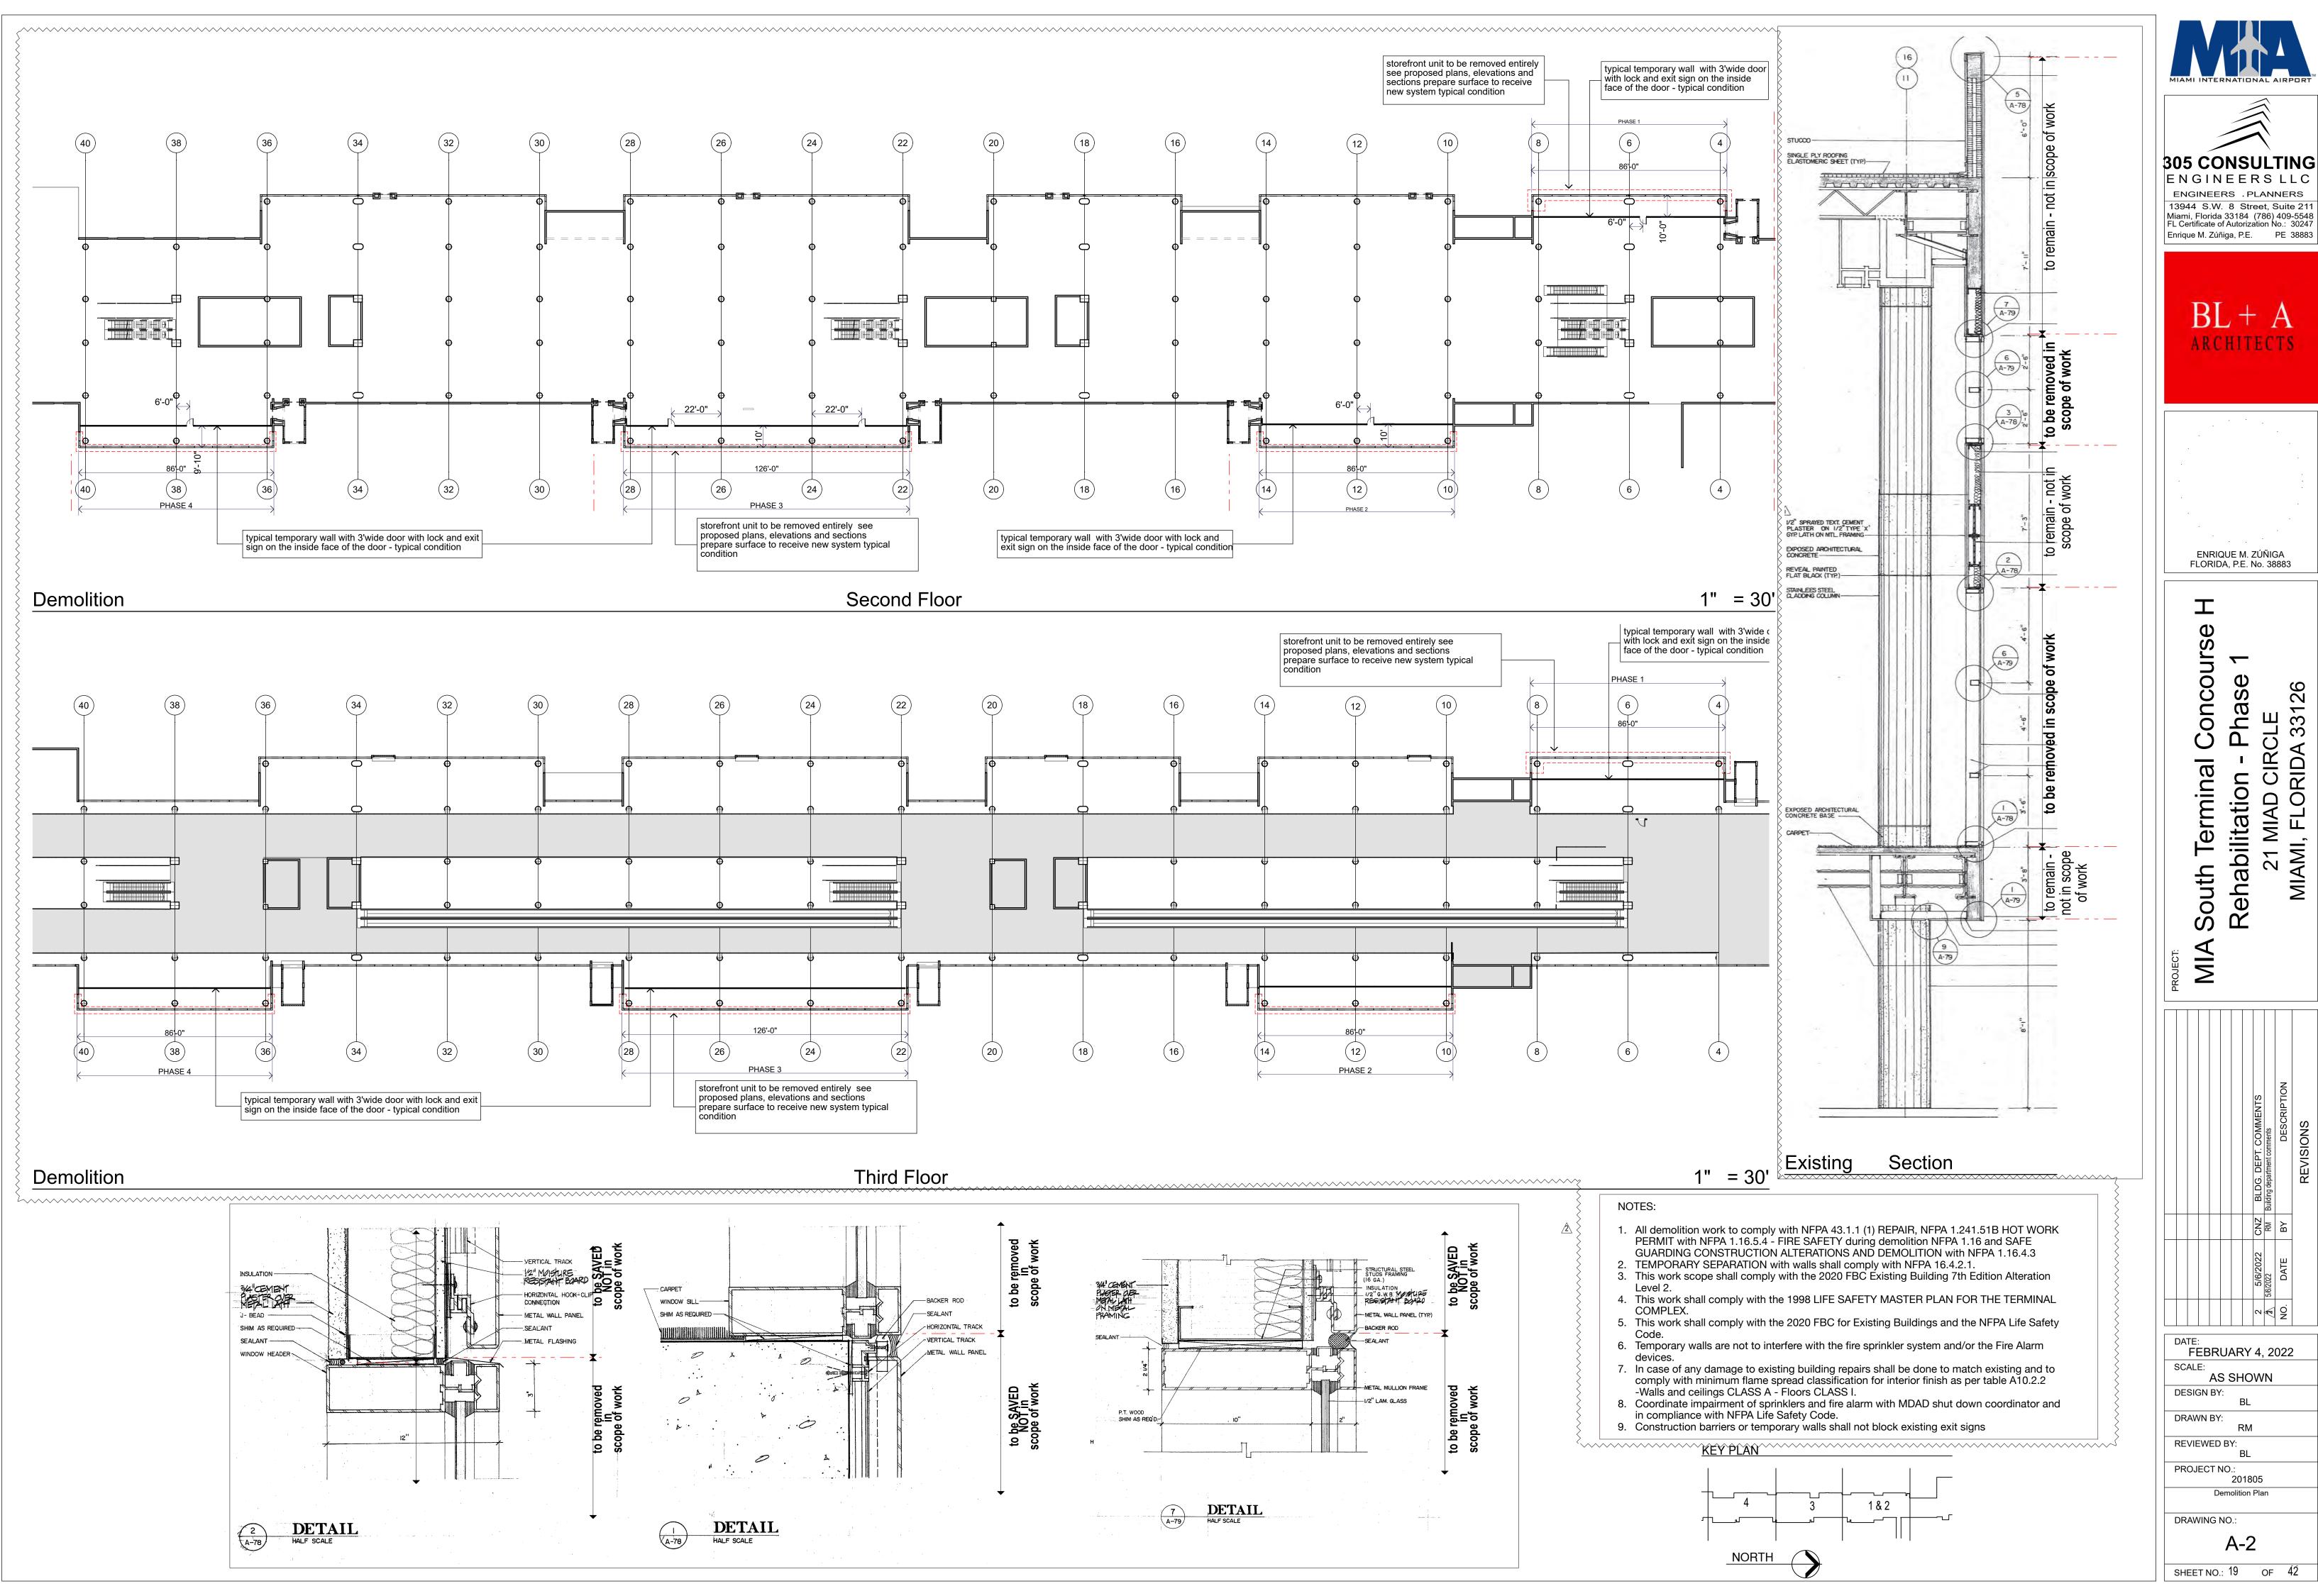
ENRIQUE M. ZÚÑIGA FLORIDA, P.E. No. 38883

A South Terminal Concourse H Rehabilitation - Phase 1

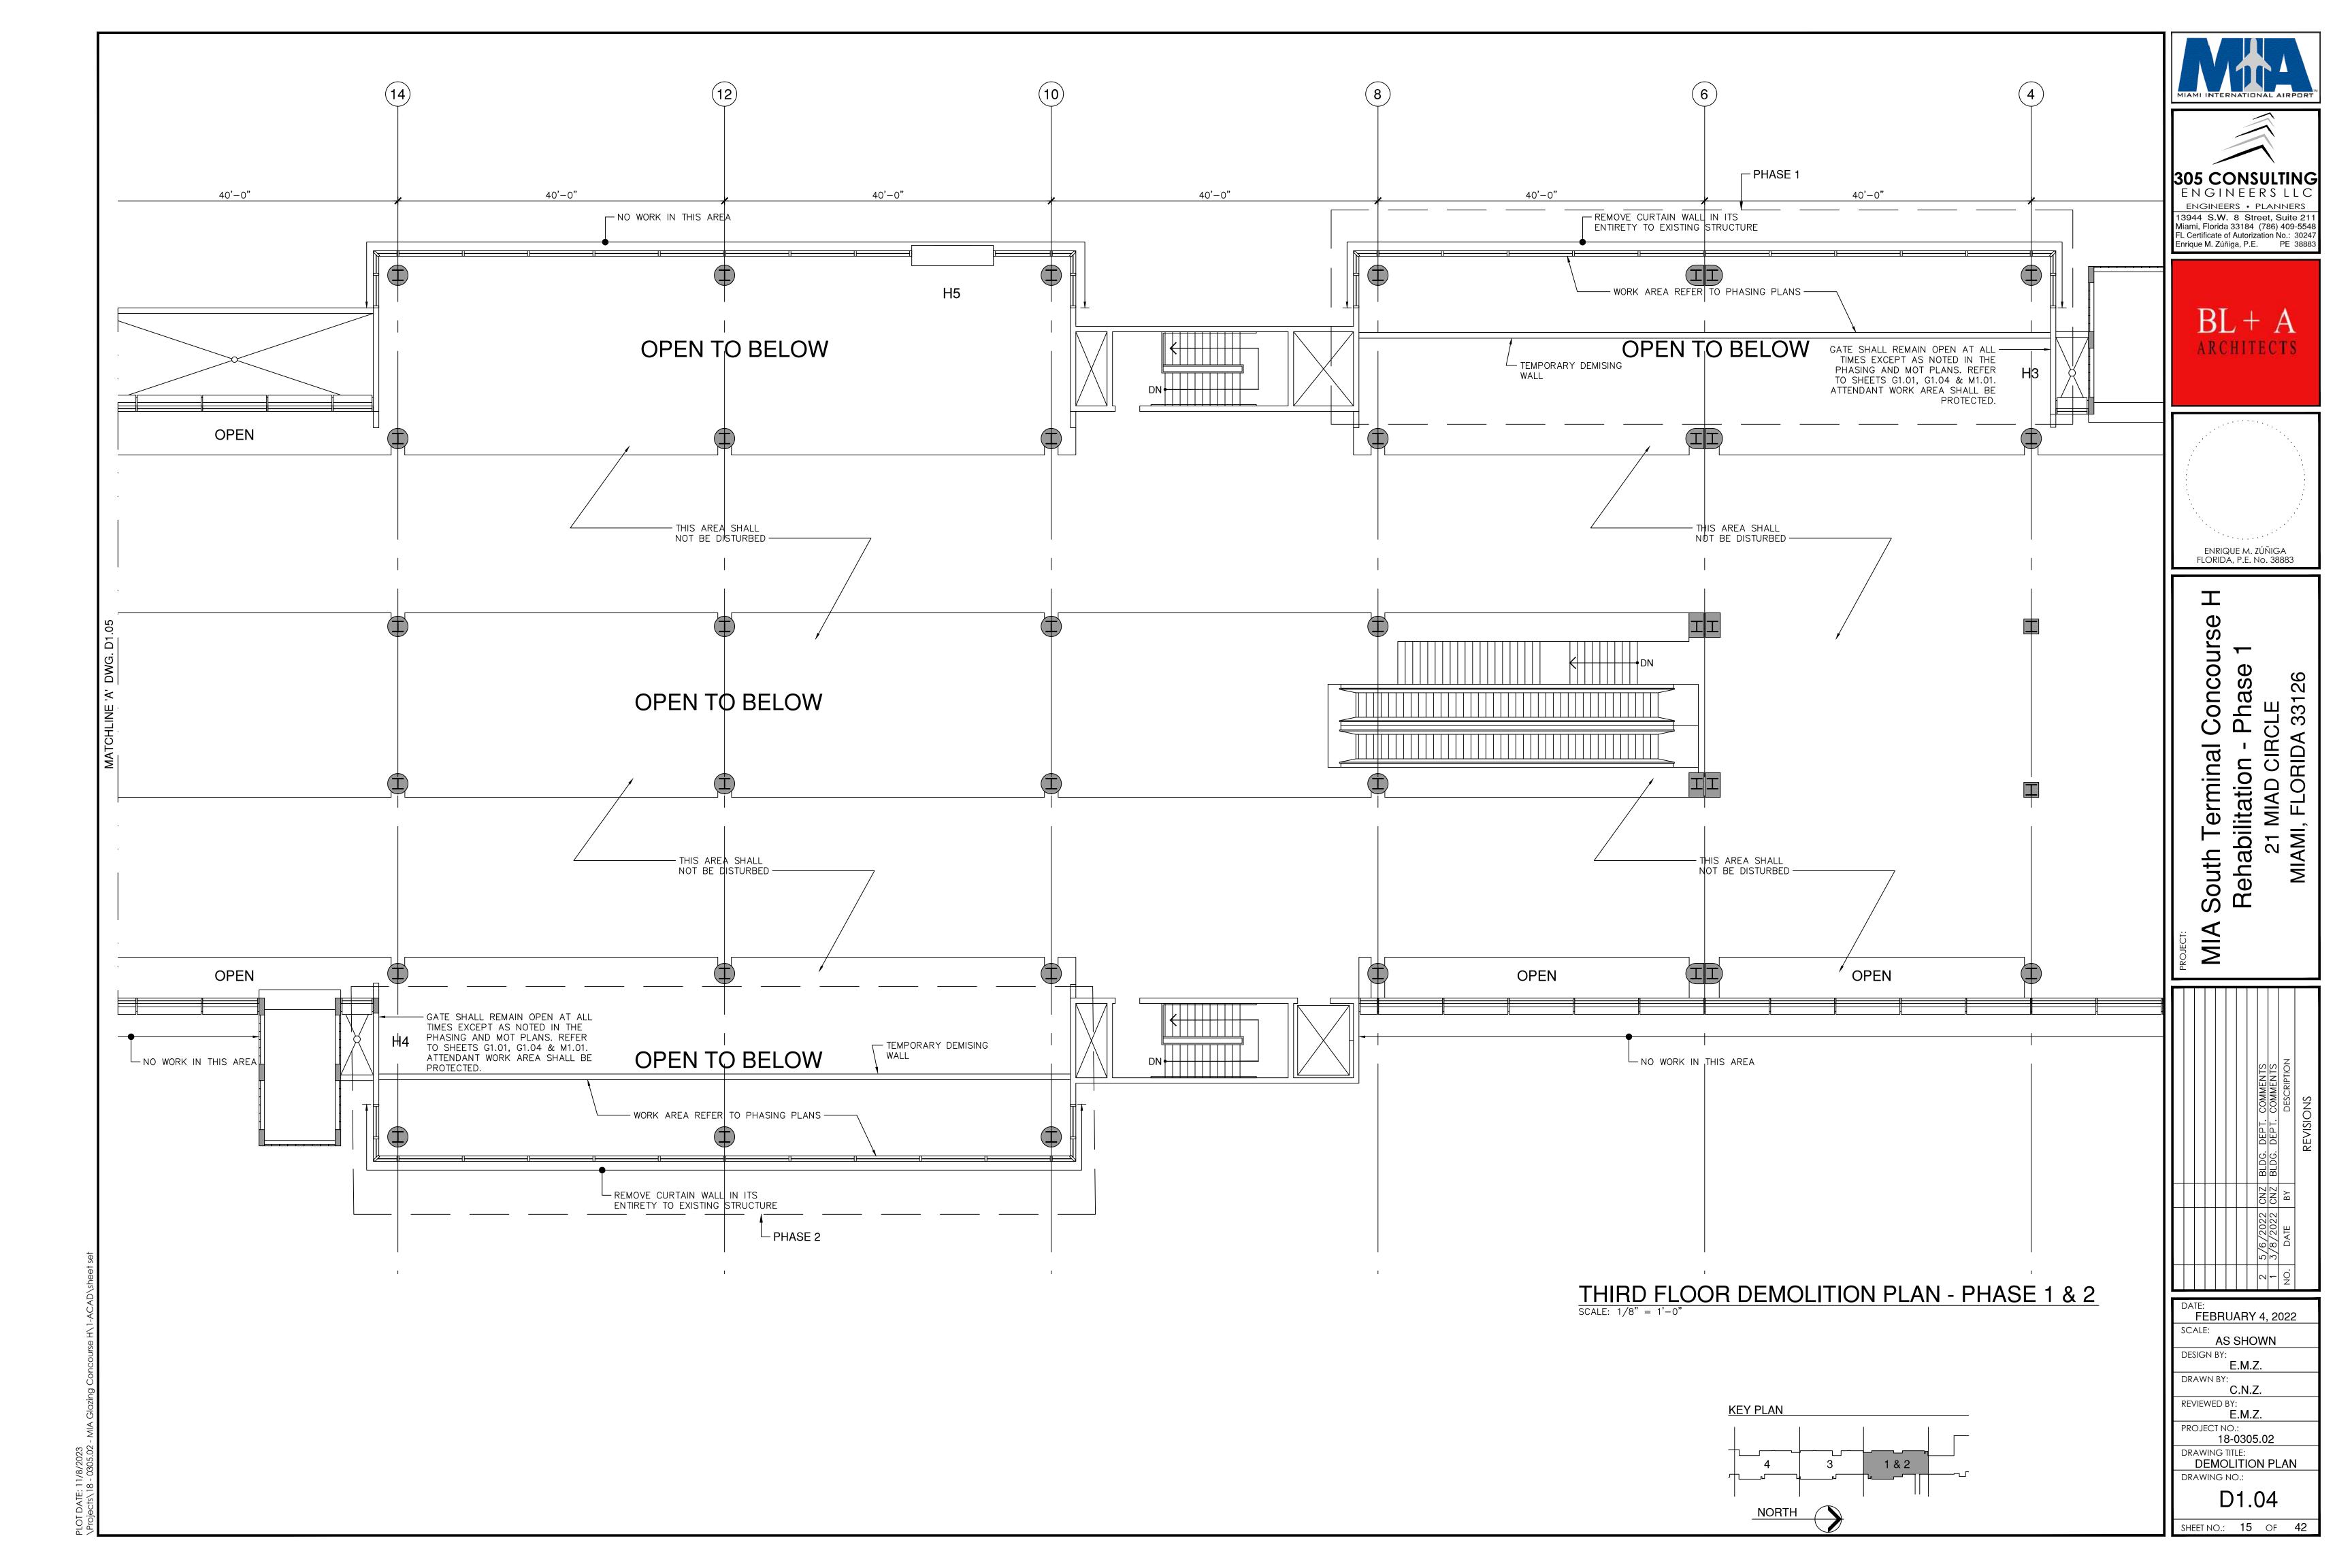DATE:
FEBRUARY 4, 2022
SCALE:
AS SHOWN
DESIGN BY:
BL
DRAWN BY:
RM
REVIEWED BY:
BL
PROJECT NO.:
201805
Referenced Existing Life Safety Plan
DRAWING NO.:

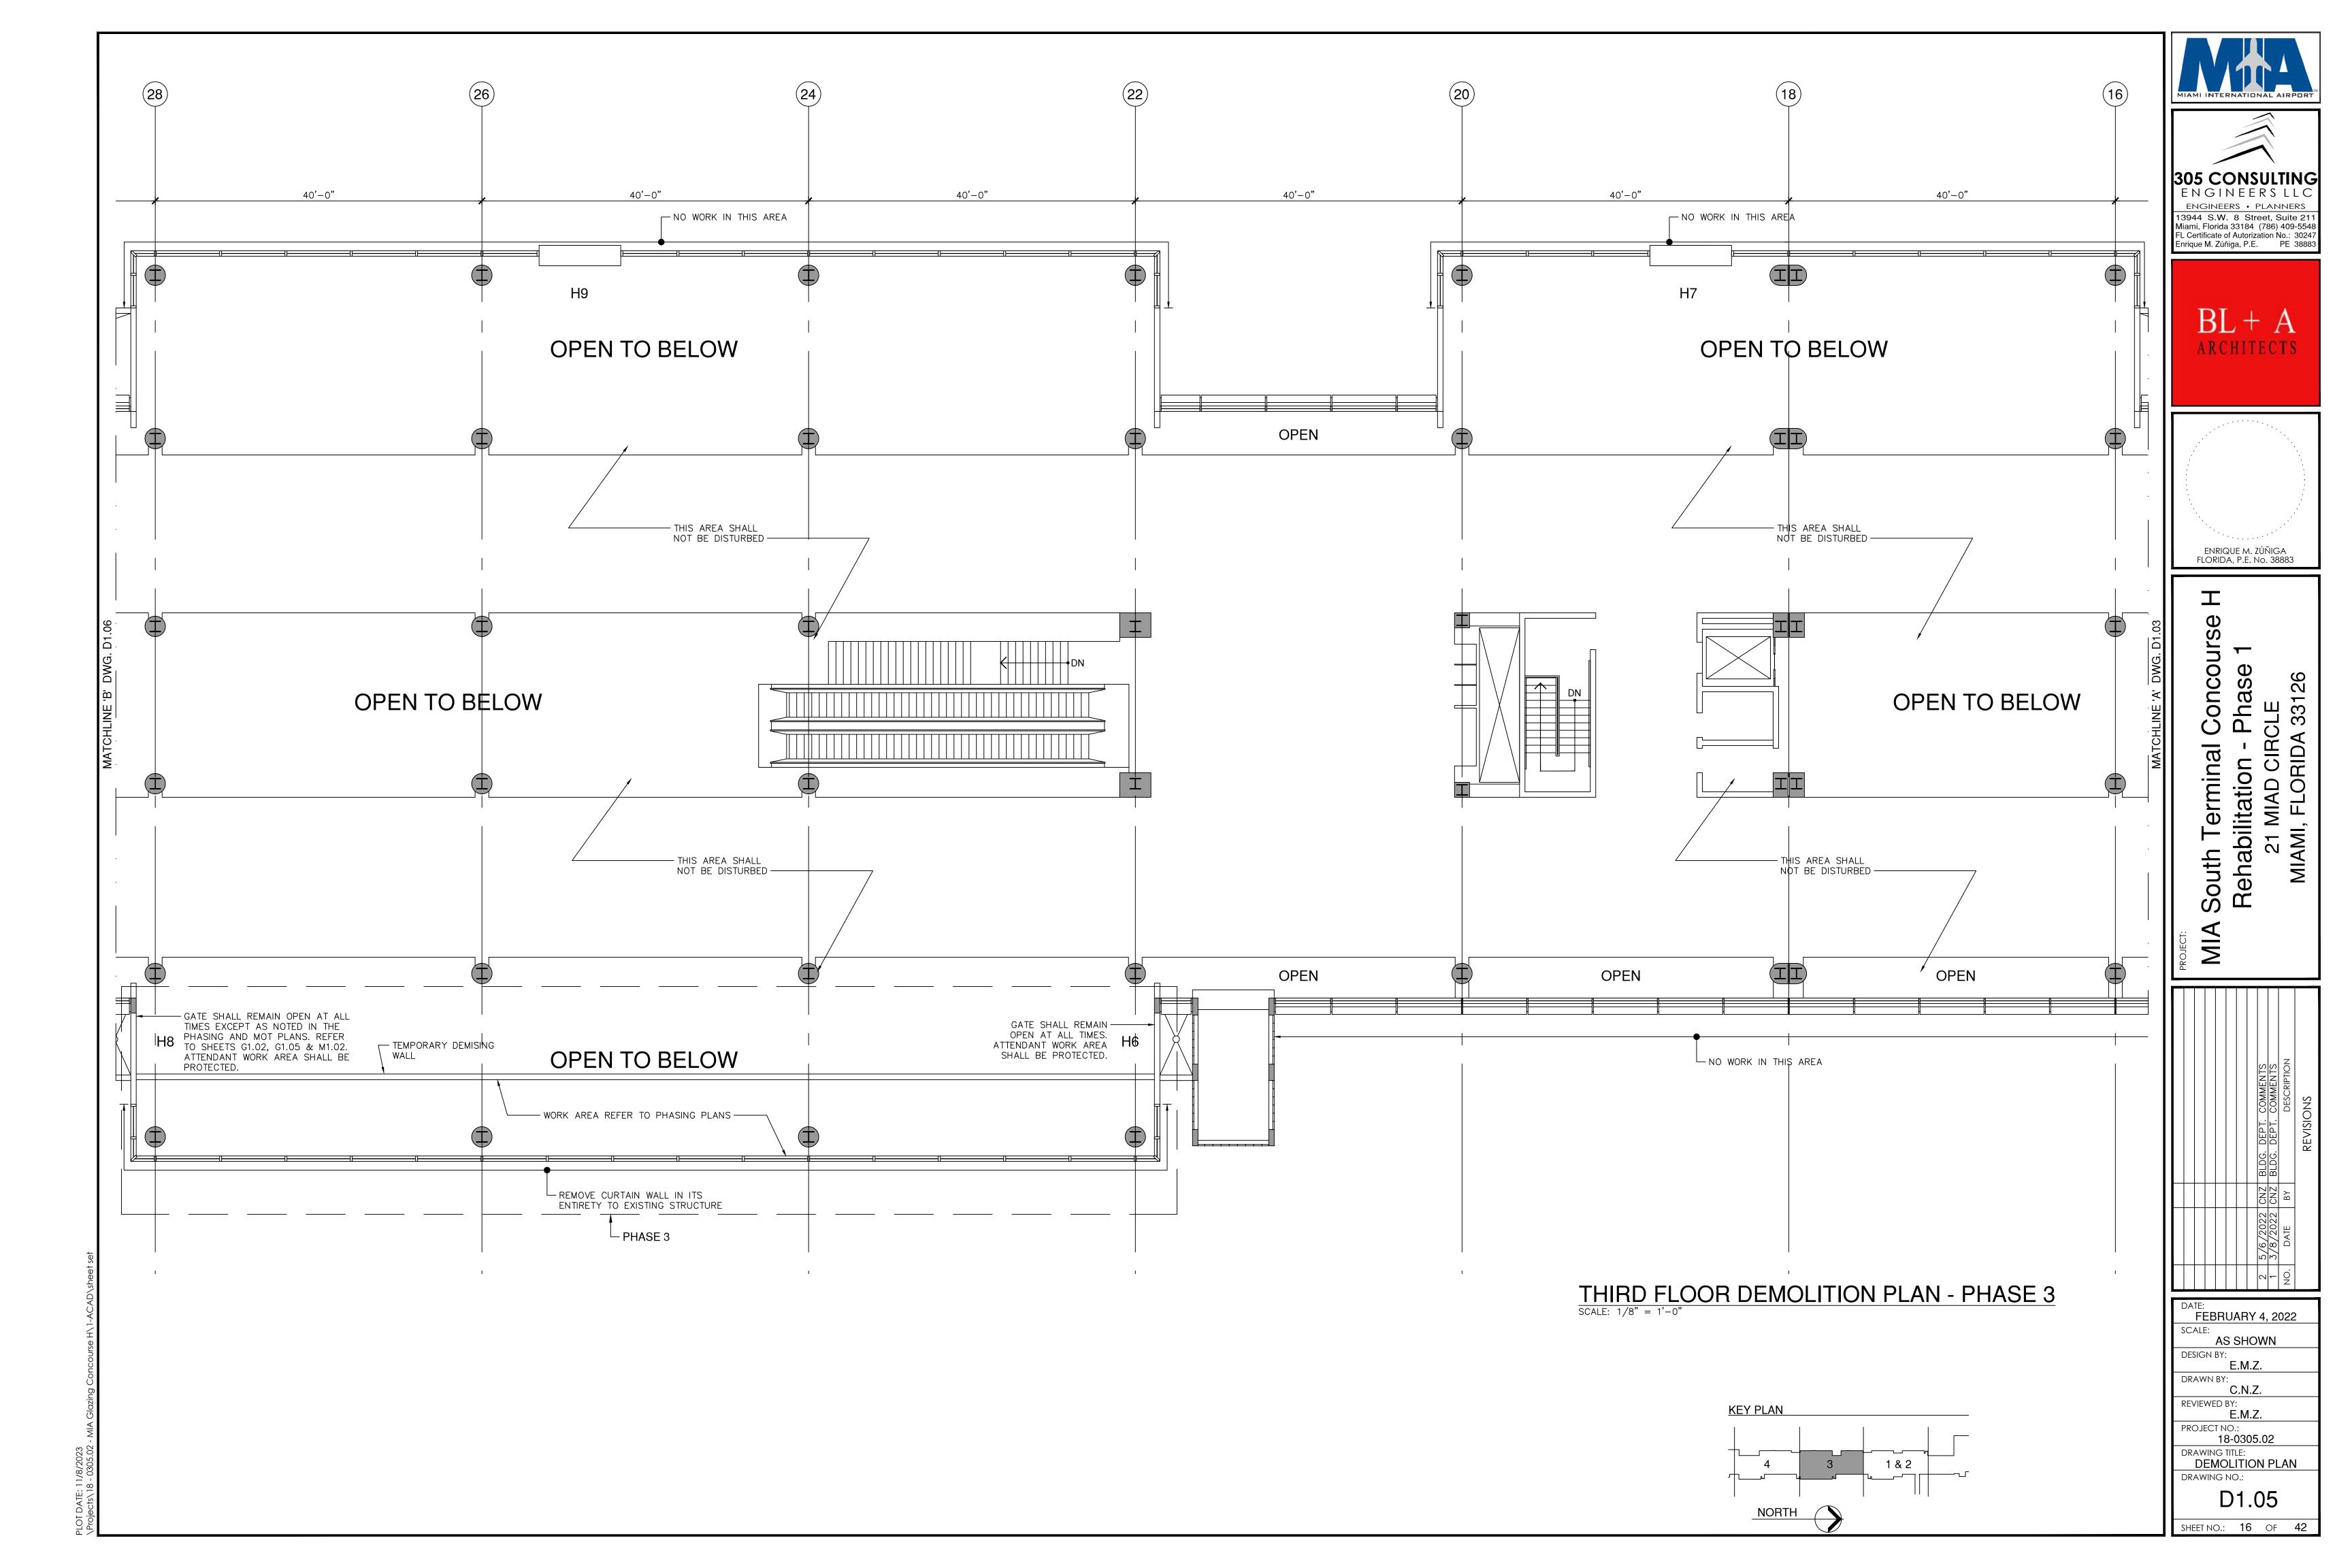WING NO.: **A-1** 

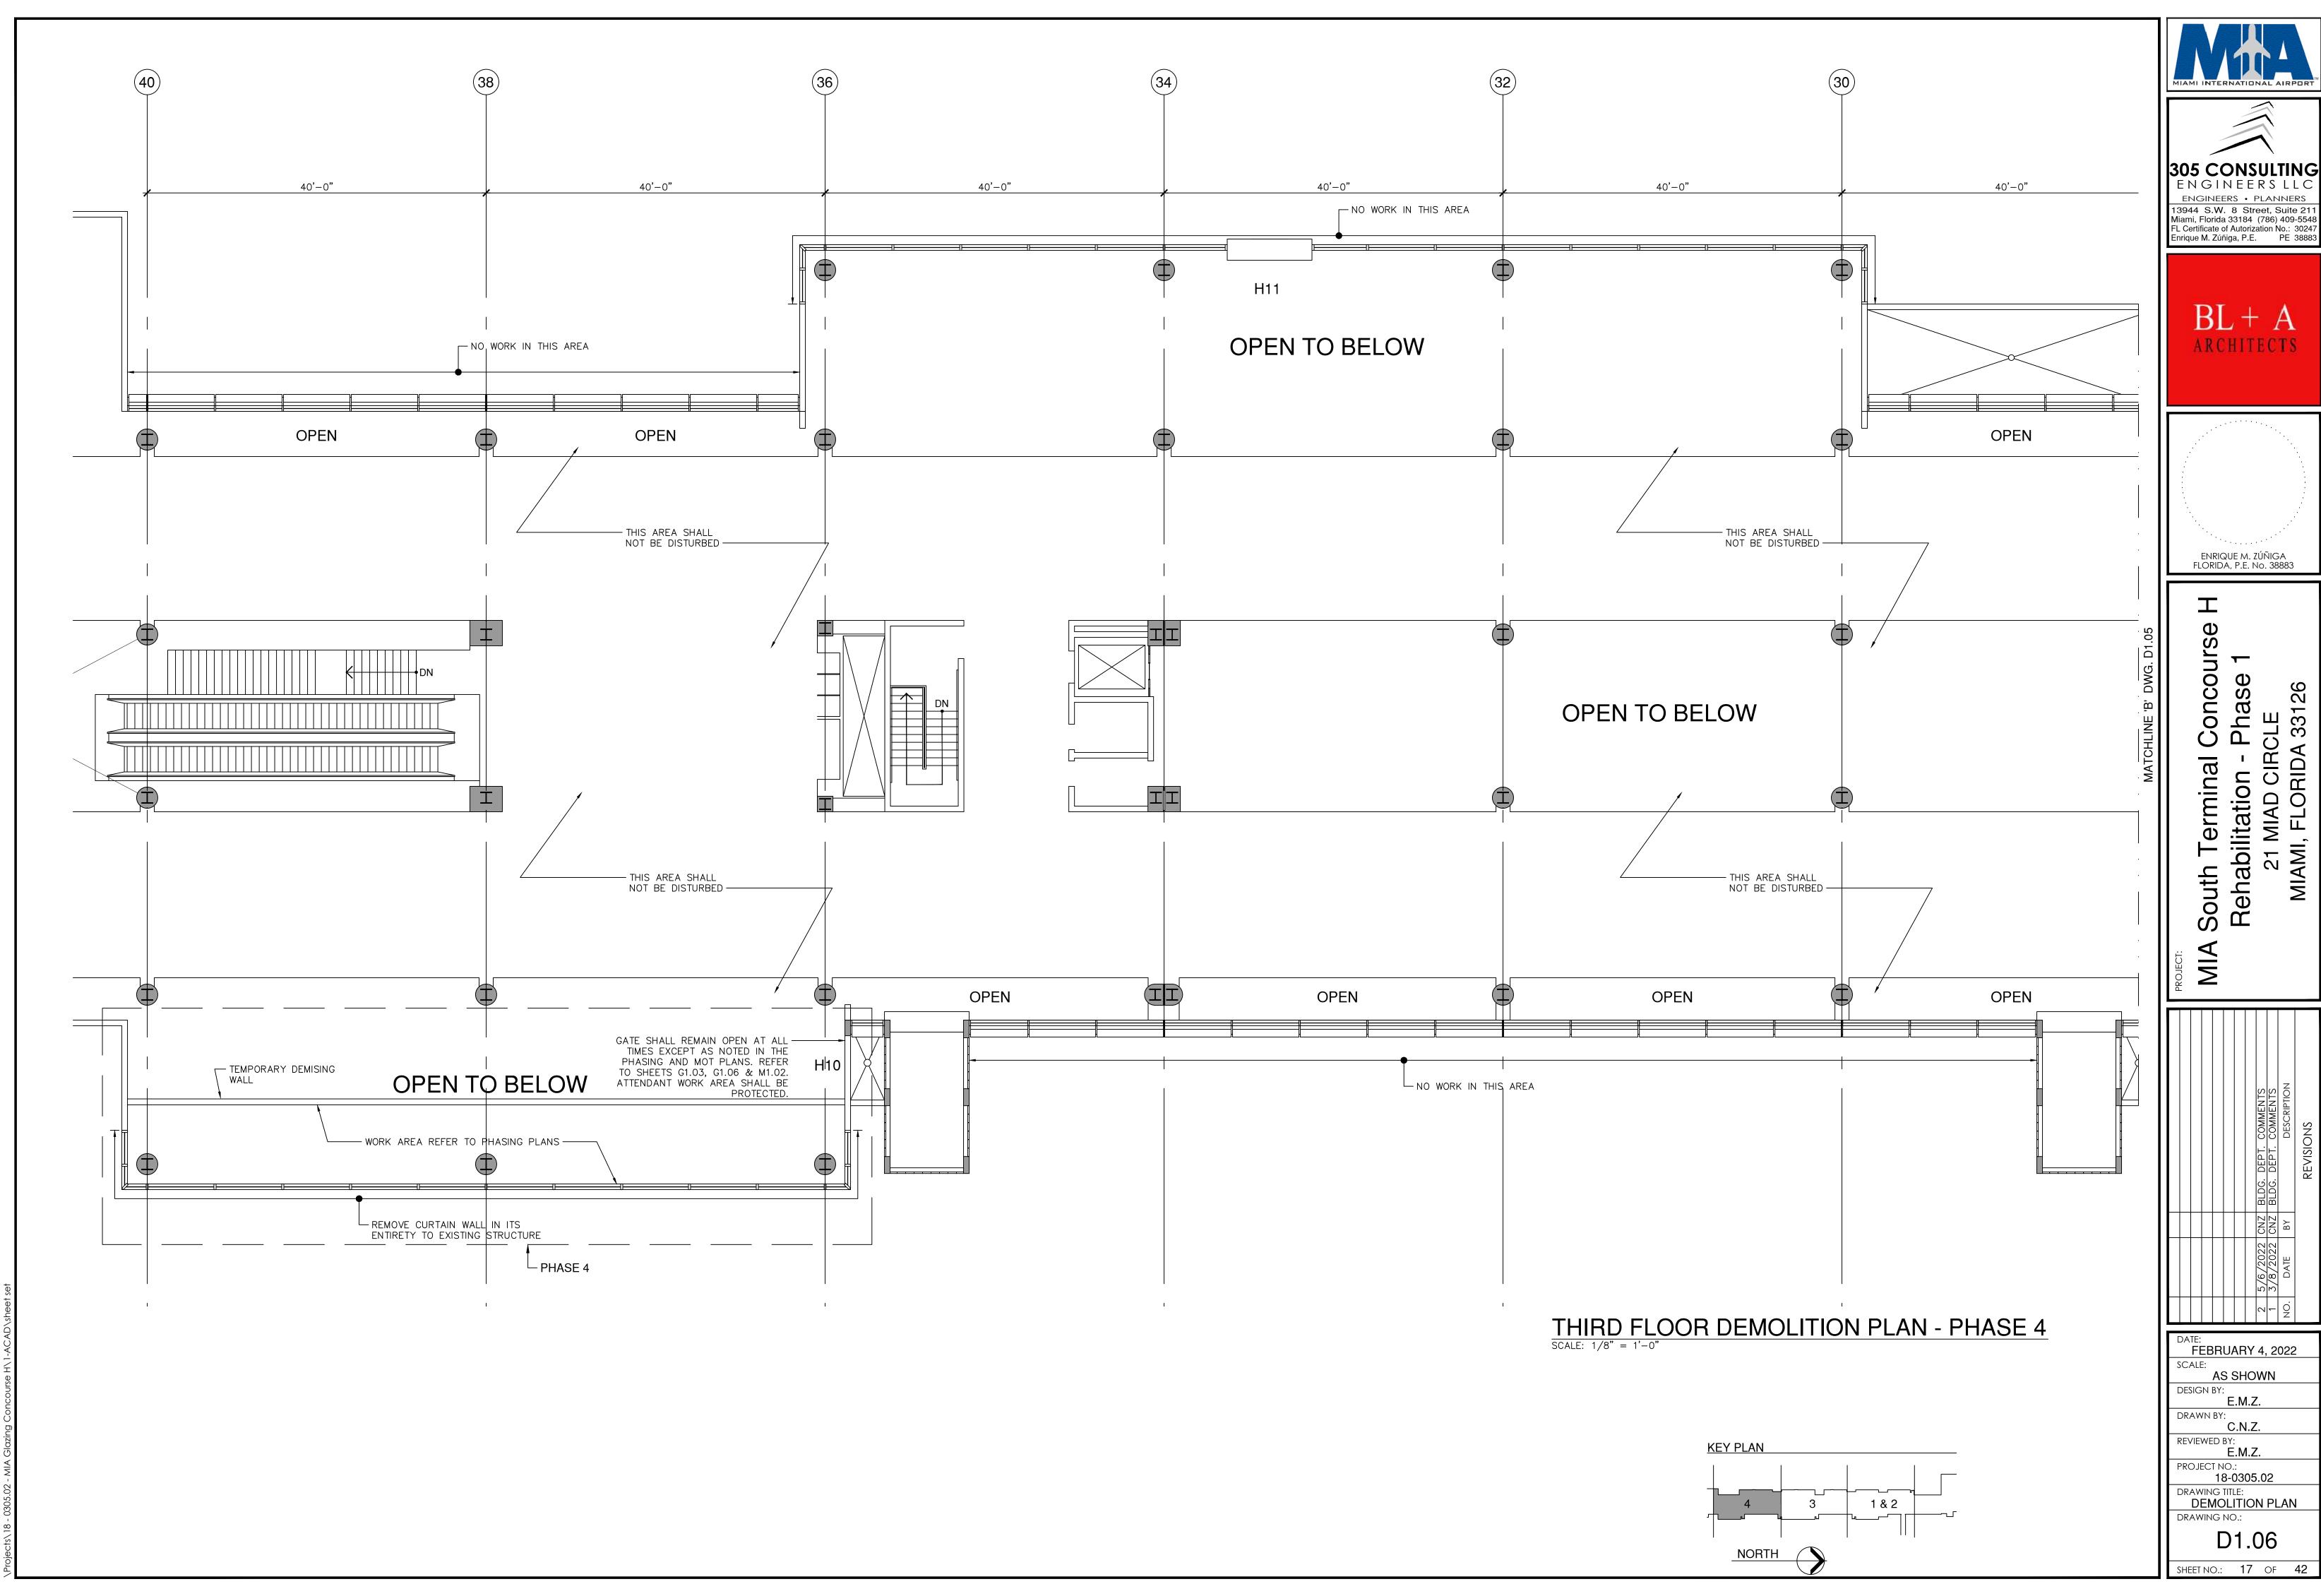SHEET NO. 18 OF 42

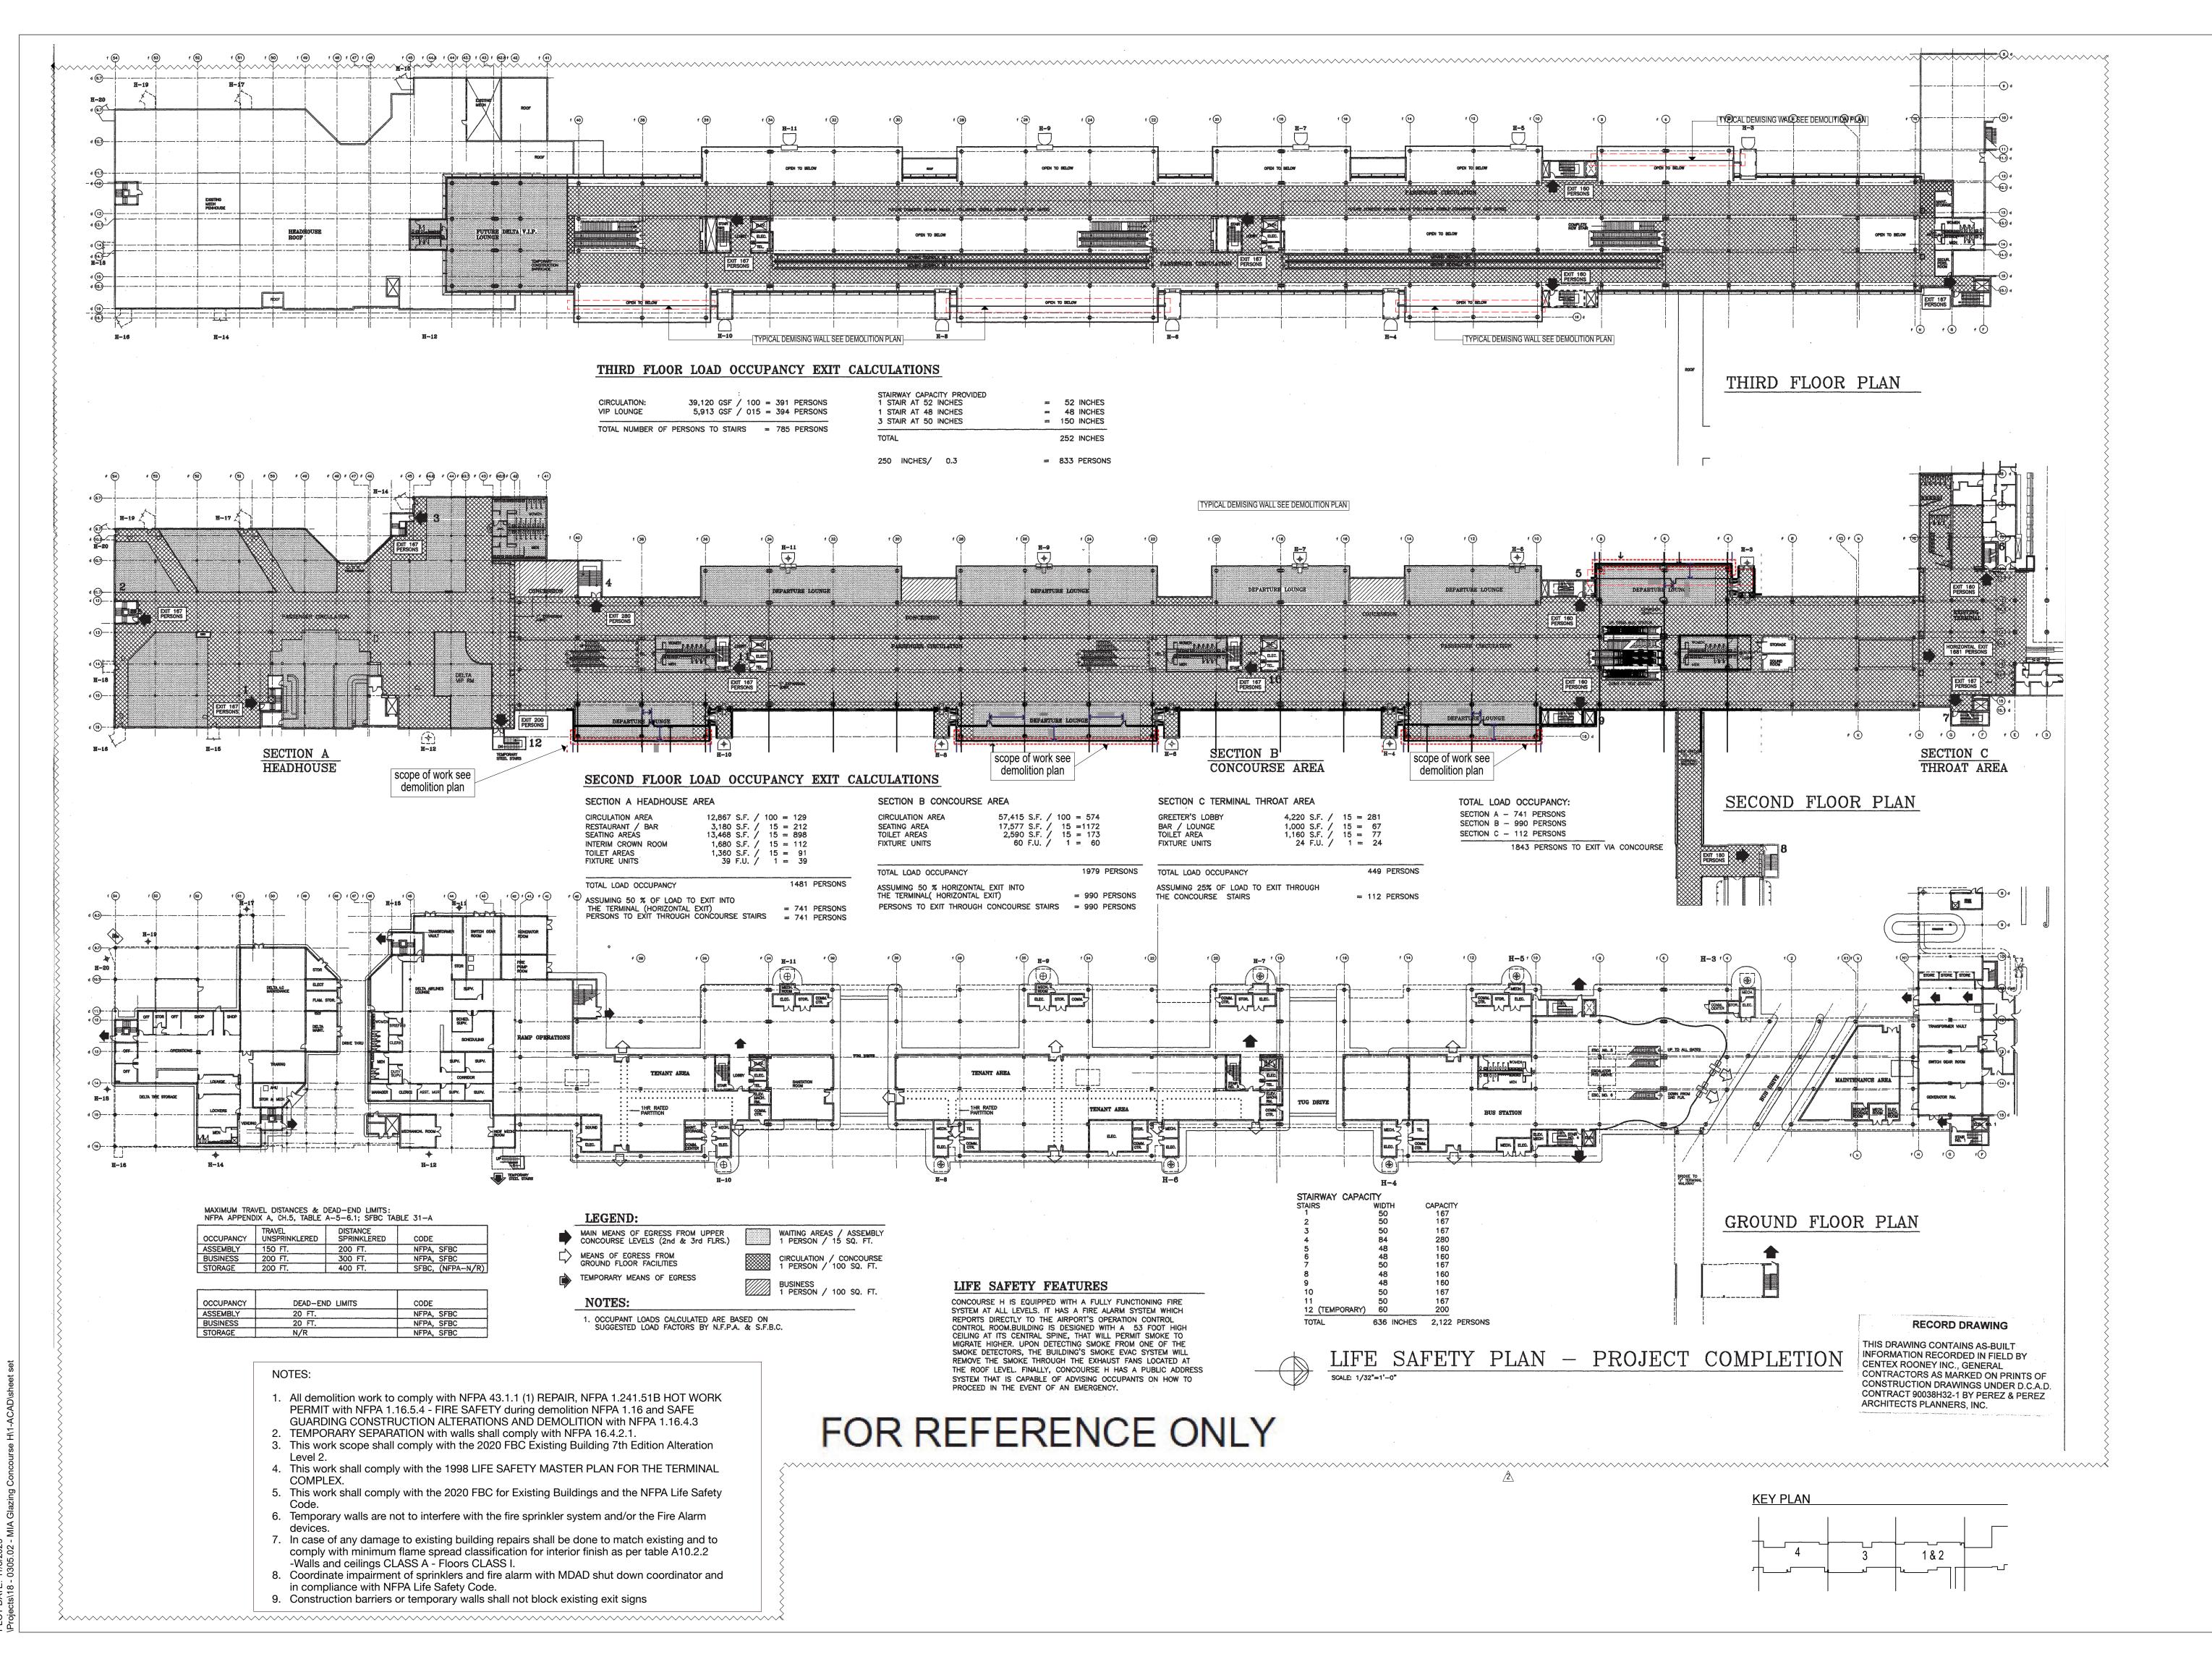





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ENRIQUE M. ZÚÑIGA

FLORIDA, P.E. No. 38883


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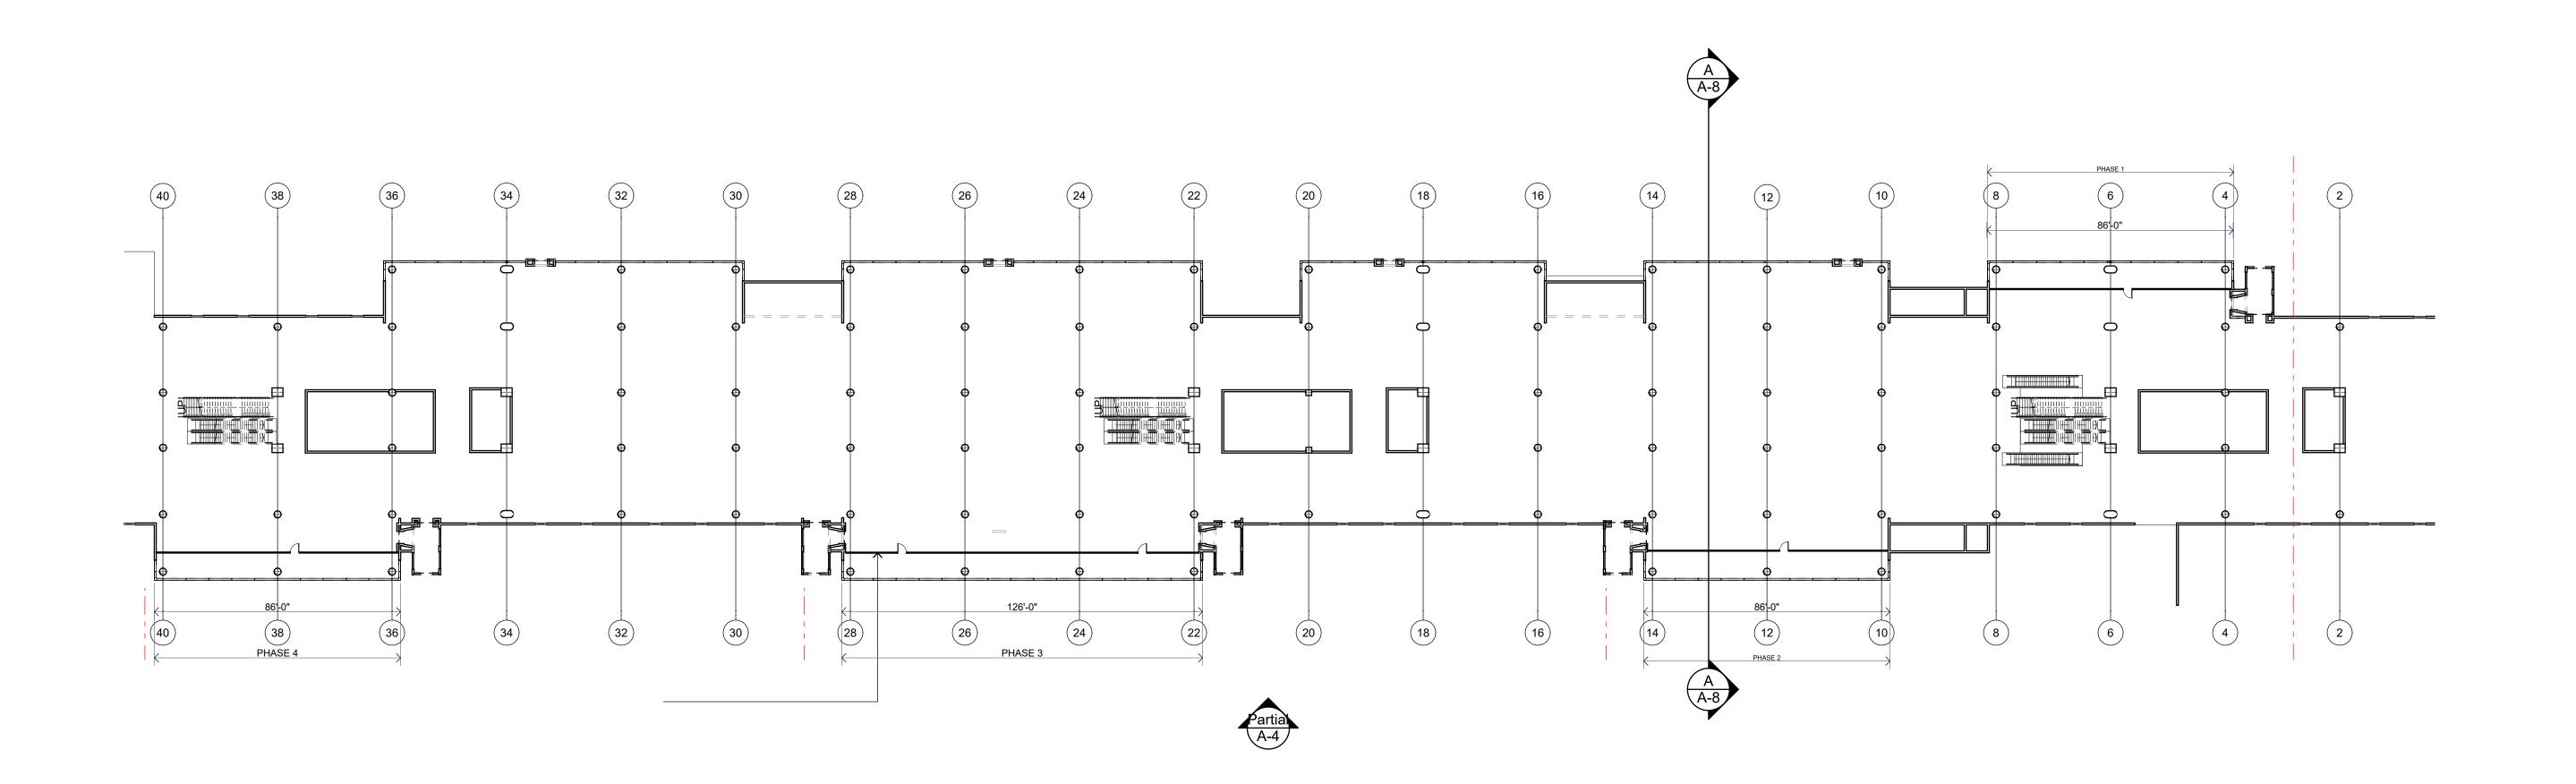
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A-2 SHEET NO.: 19 OF 42



Third Floor Plan



Second Floor Plan

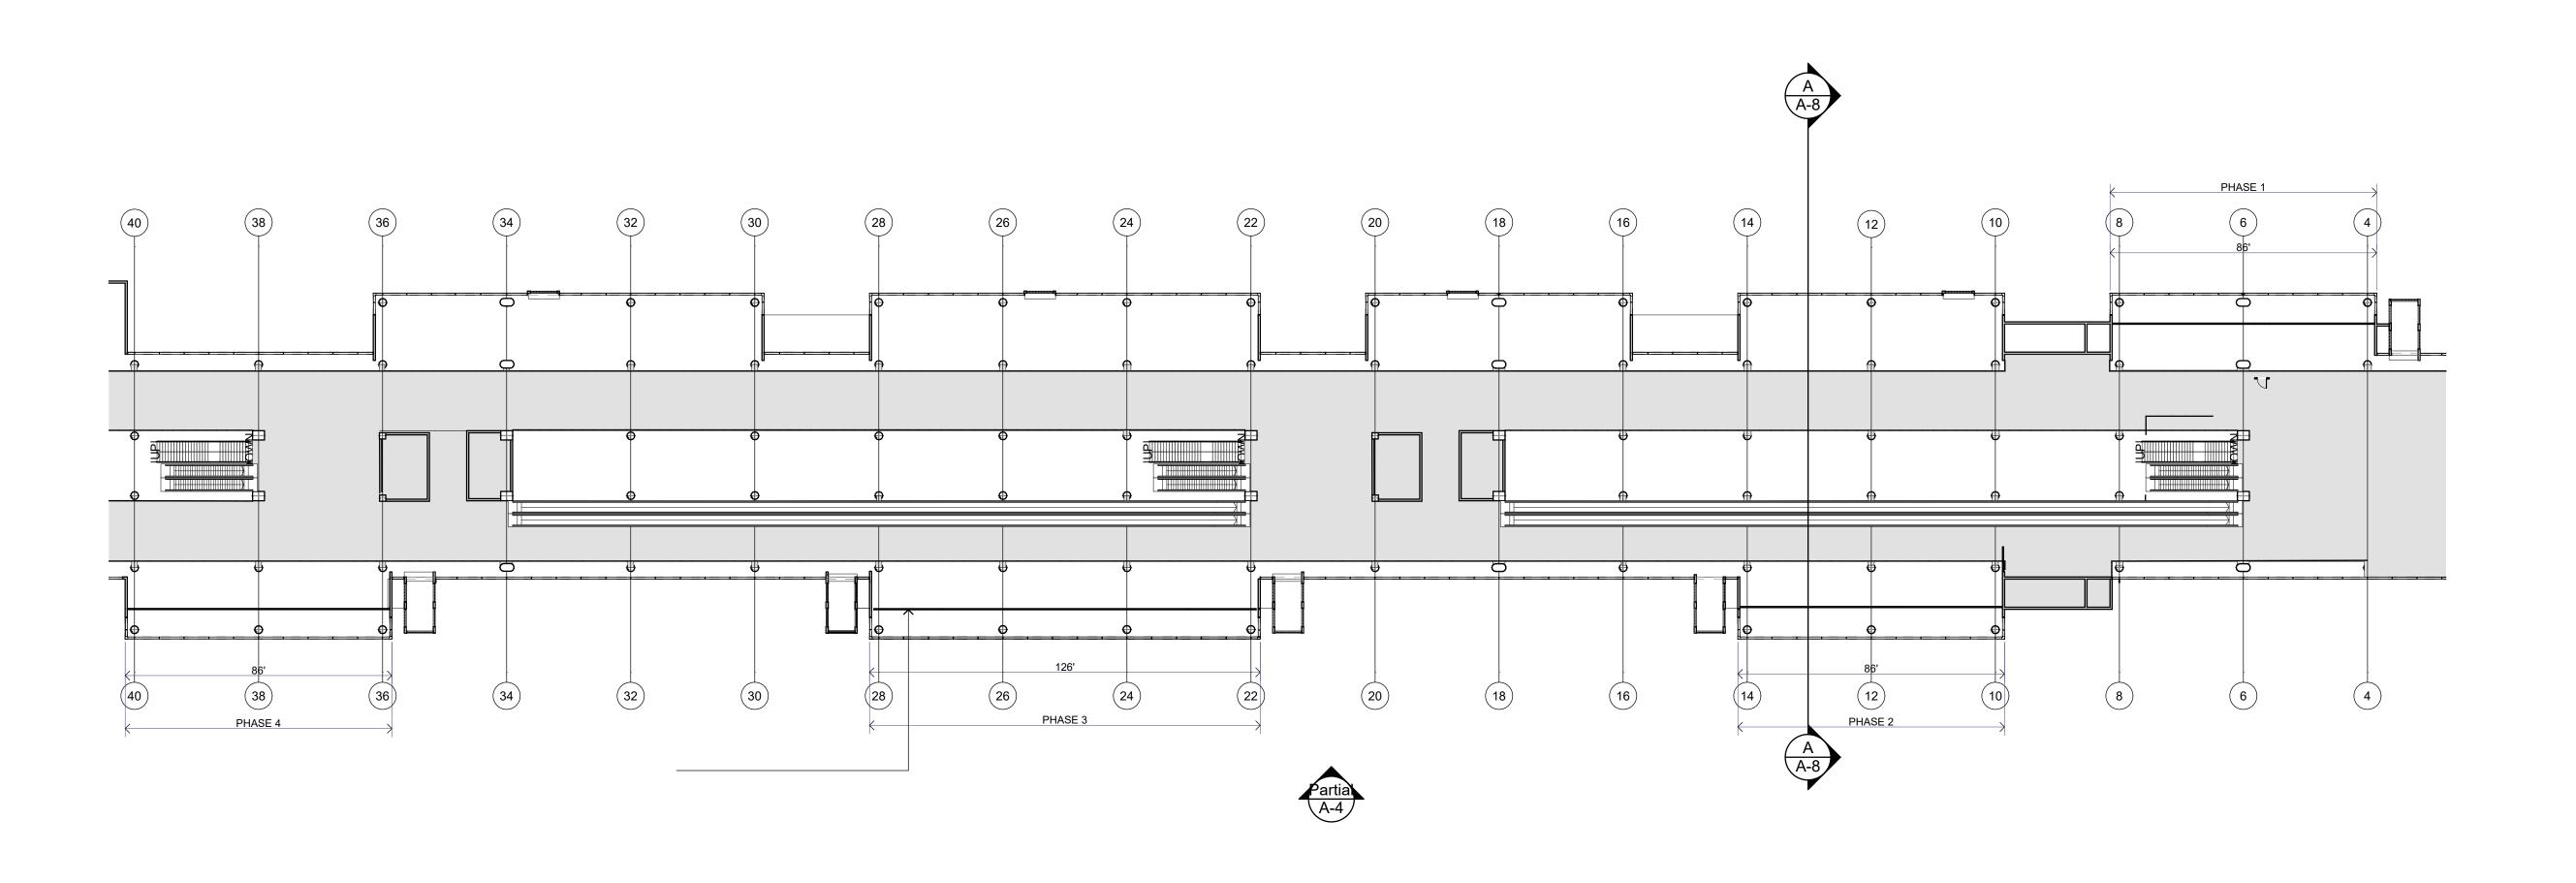5/6/2022 CNZ BLDG. DEPT. COMMENTS
3/8/2022 CNZ BLDG. DEPT. COMMENTS
3/8/2022 CNZ BLDG. DEPT. COMMENTS
DATE BY DESCRIPTION
REVISIONS

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ENRIQUE M. ZÚÑIGA FLORIDA, P.E. No. 38883

A South Terminal Concoul Rehabilitation - Phase 121 MIAD CIRCLE MIAMI, FLORIDA 33126

1" = 30'

1" = 30'

1 & 2

KEY PLAN


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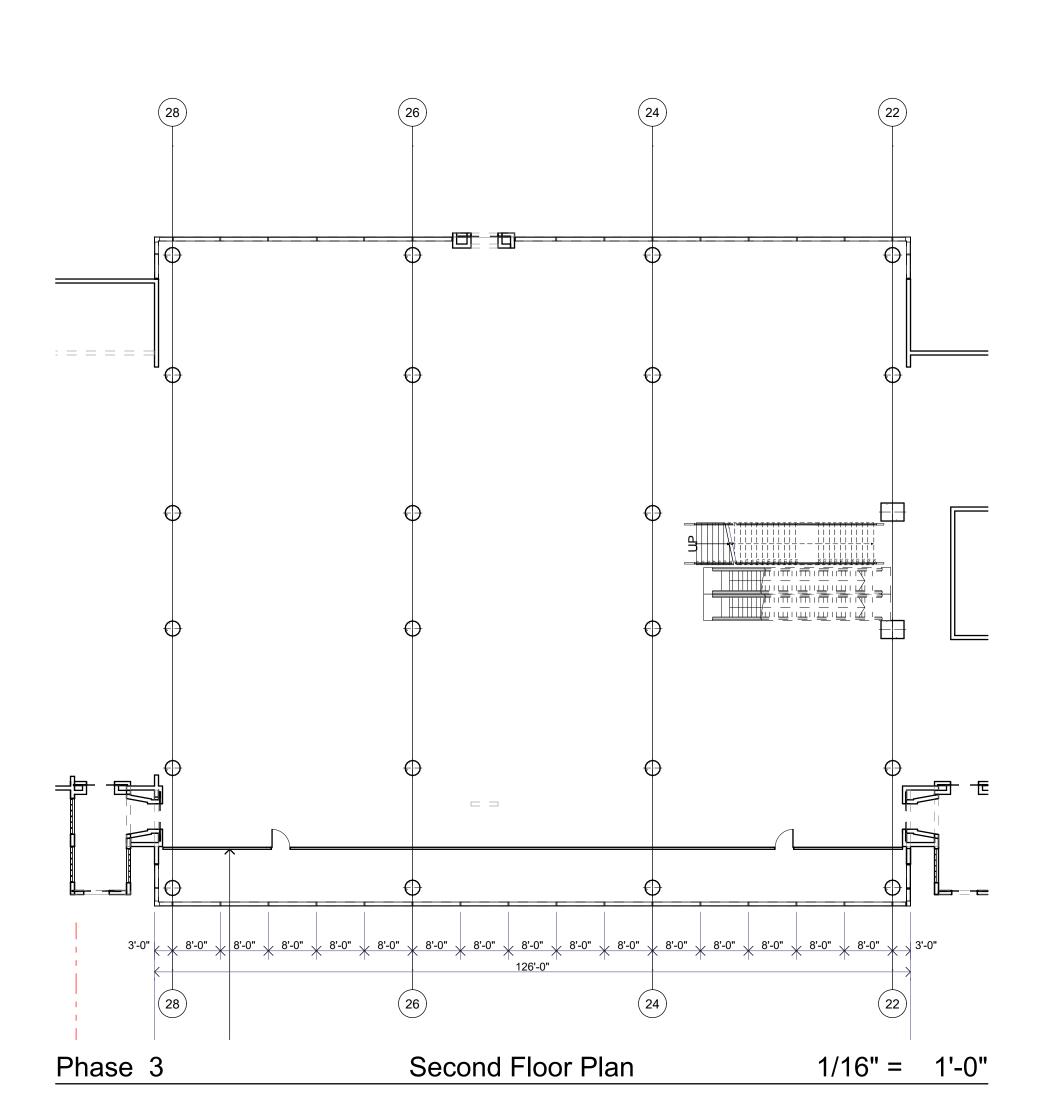
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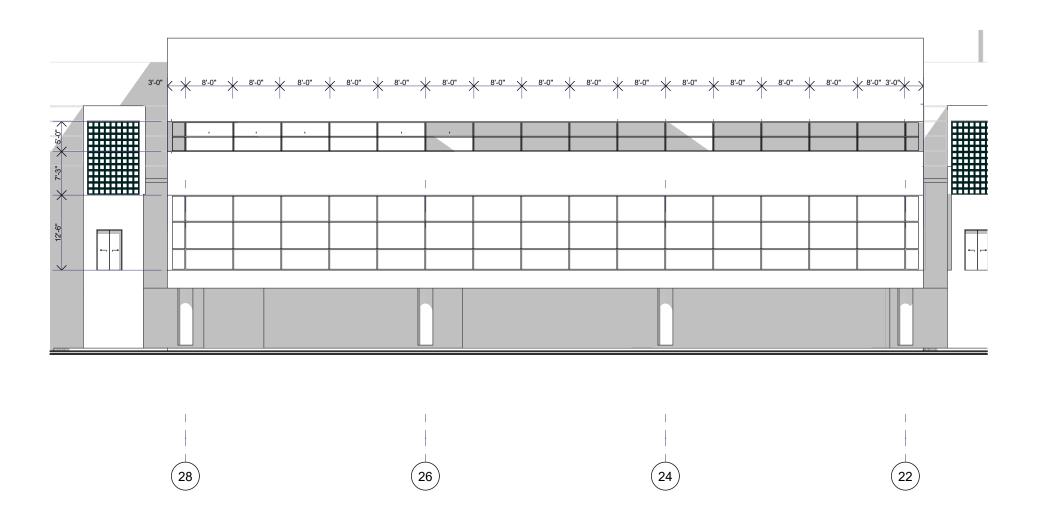


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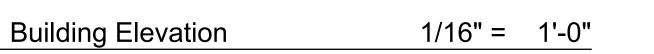
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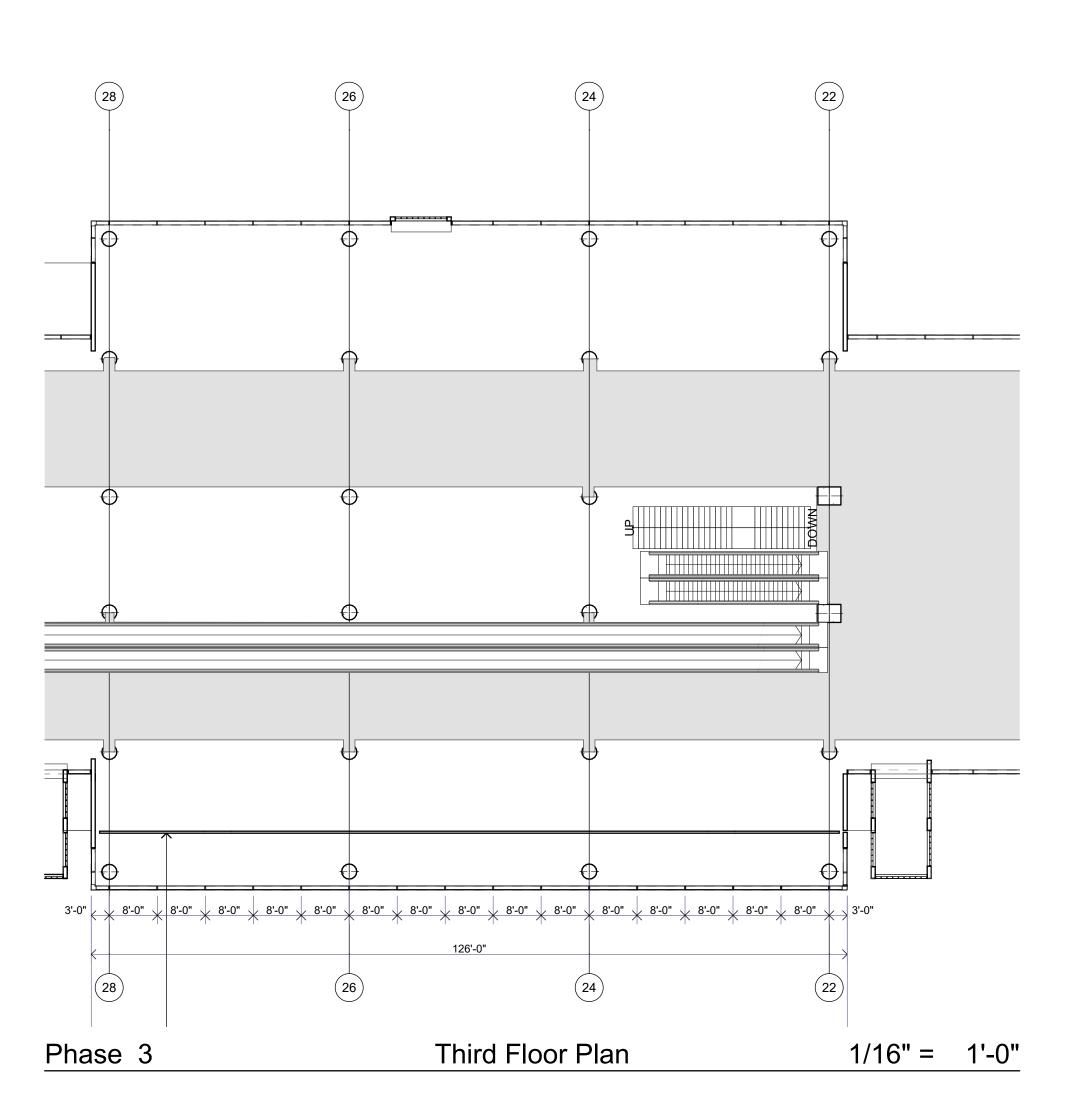
DATE: FEBRUARY 4, 2022





**Partial** 

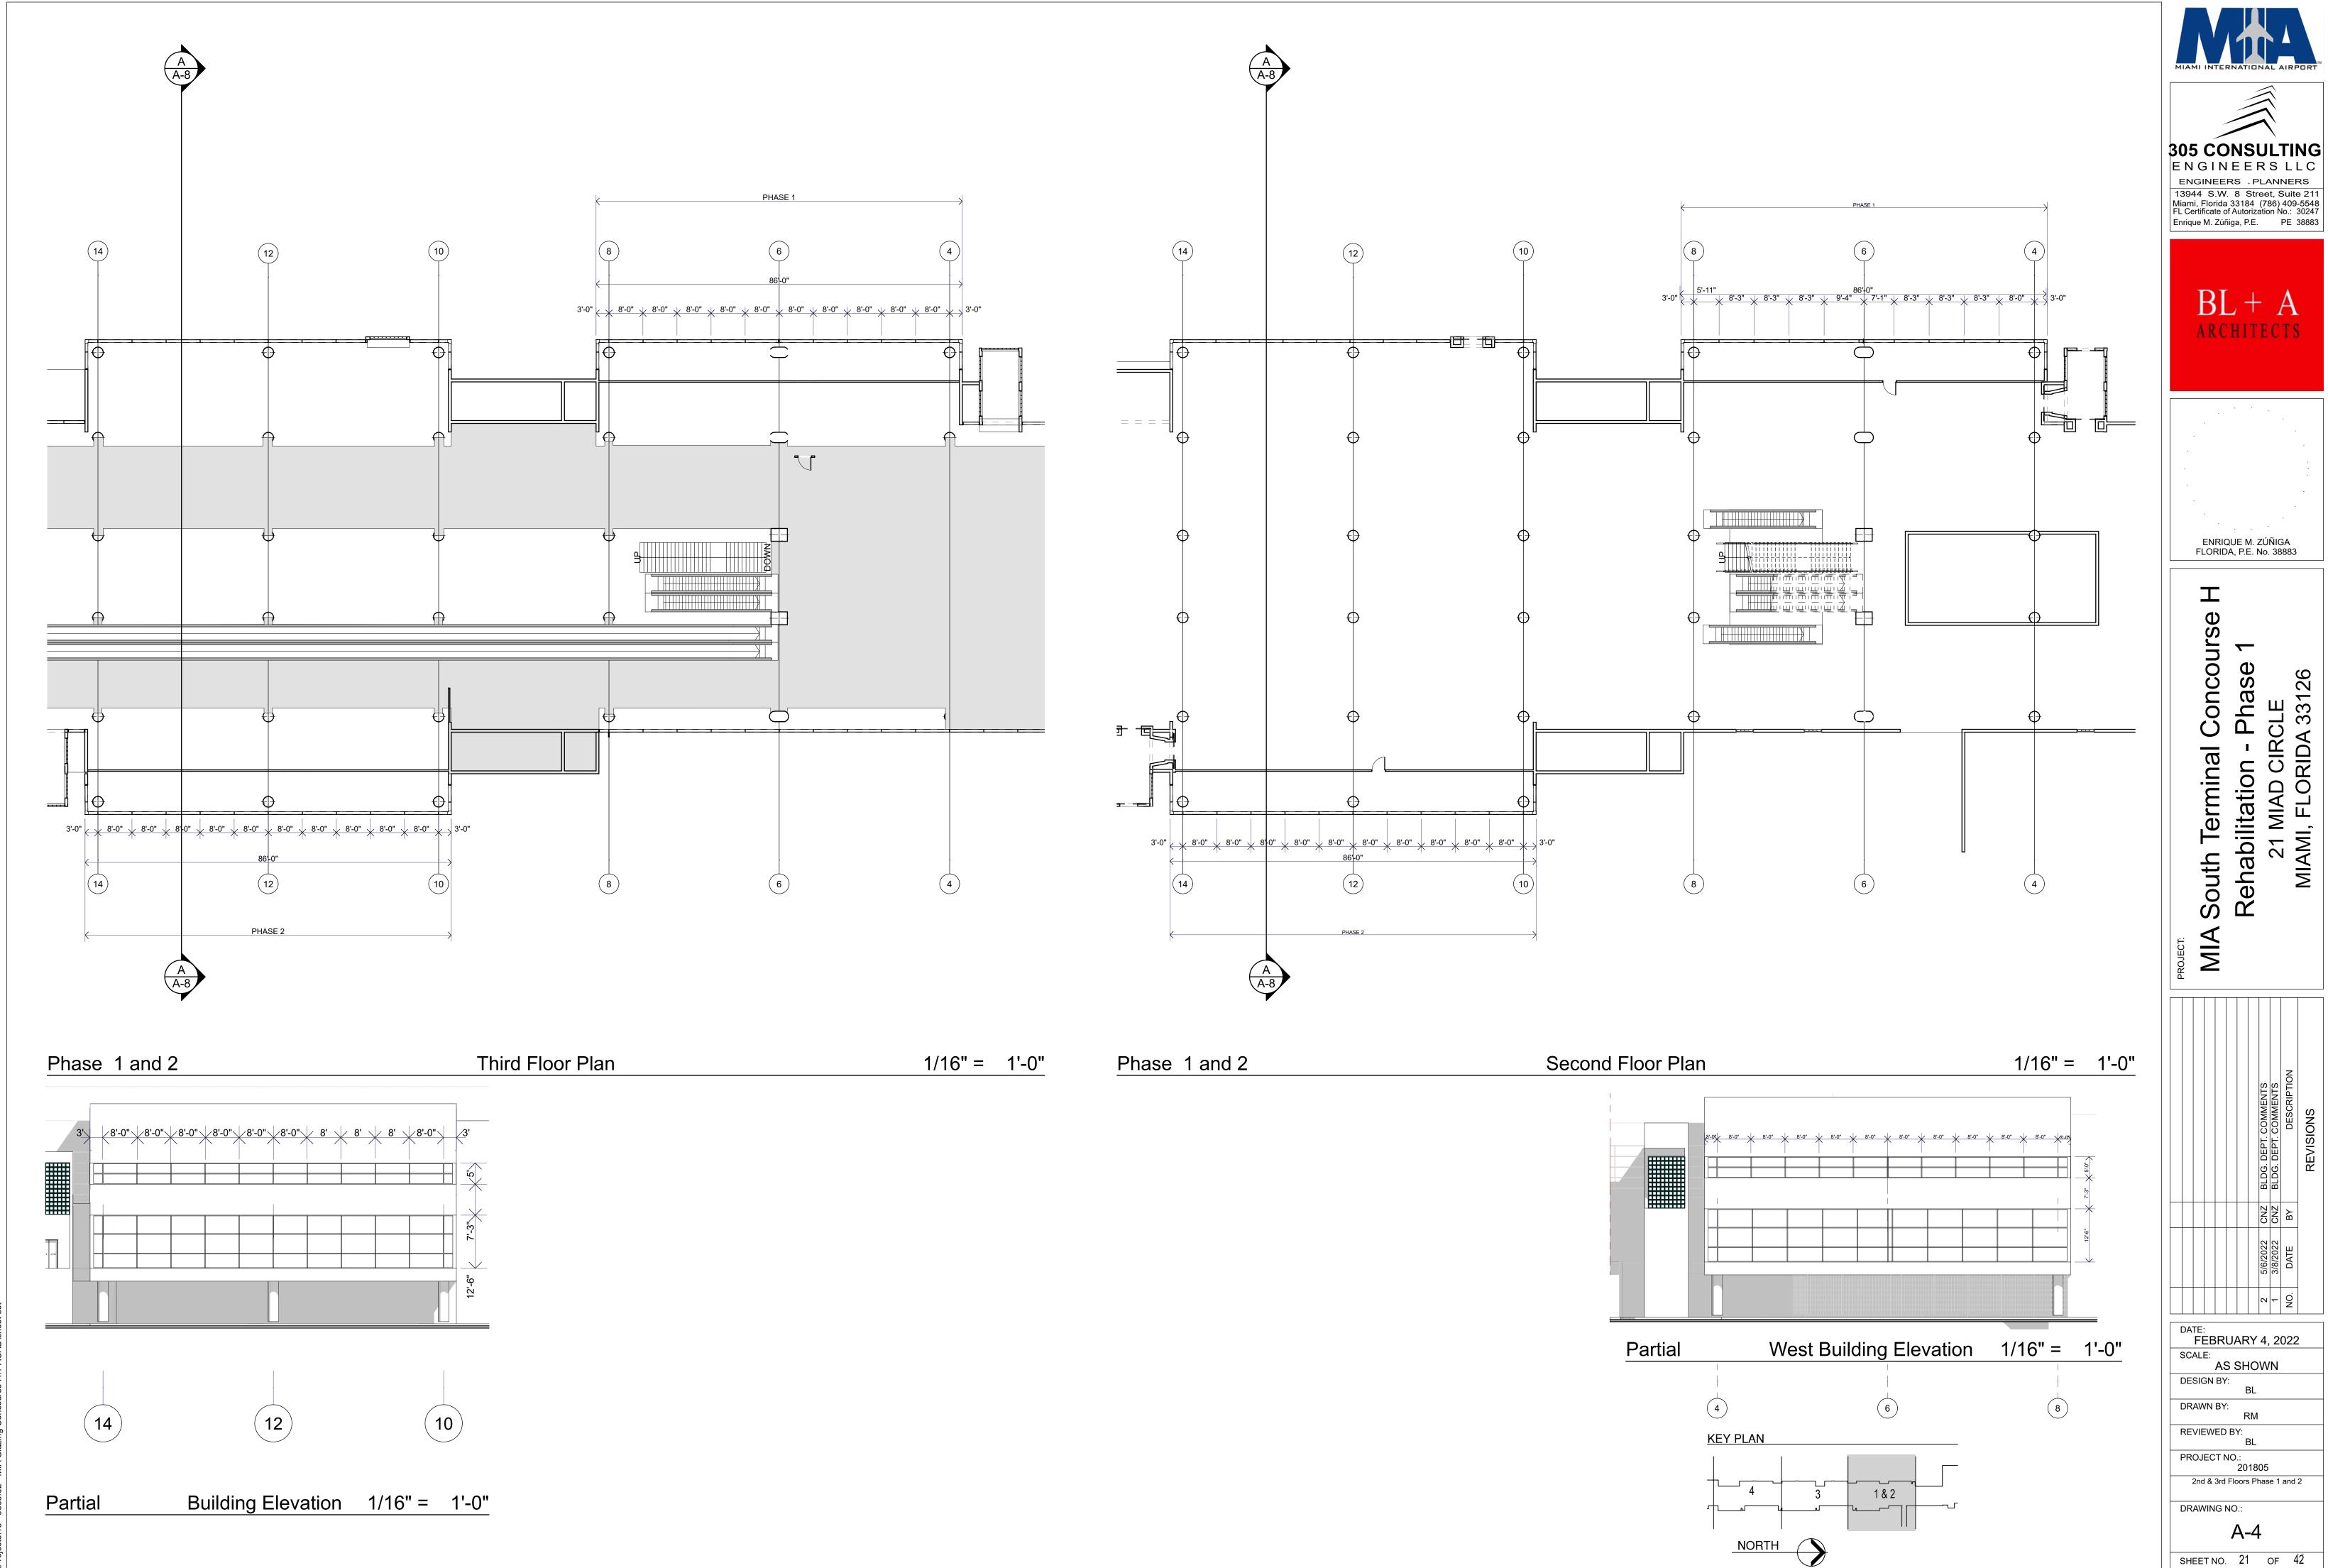



KEY PLAN

NORTH

1 & 2





BL + A
ARCHITECTS

ENRIQUE M. ZÚÑIGA FLORIDA, P.E. No. 38883

> South Terminal Concourse H Rehabilitation - Phase 1 21 MIAD CIRCLE MIAMI, FLORIDA 33126

2 5/6/2022 CNZ BLDG. DEPT. COMMENTS
1 3/8/2022 CNZ BLDG. DEPT. COMMENTS
NO. DATE BY DESCRIPTION
REVISIONS

DATE:
FEBRUARY 4, 2022
SCALE:
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REVIEWED BY:
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PROJECT NO.:
201805
2nd &3rd Floor Phase 3


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SHEET NO. 22 OF 42







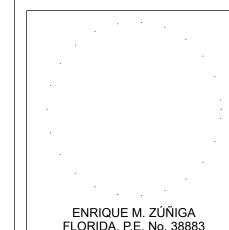

ENRIQUE M. ZÚÑIGA FLORIDA, P.E. No. 38883

A South Terminal Concourse Rehabilitation - Phase 1 21 MIAD CIRCLE MIAMI, FLORIDA 33126

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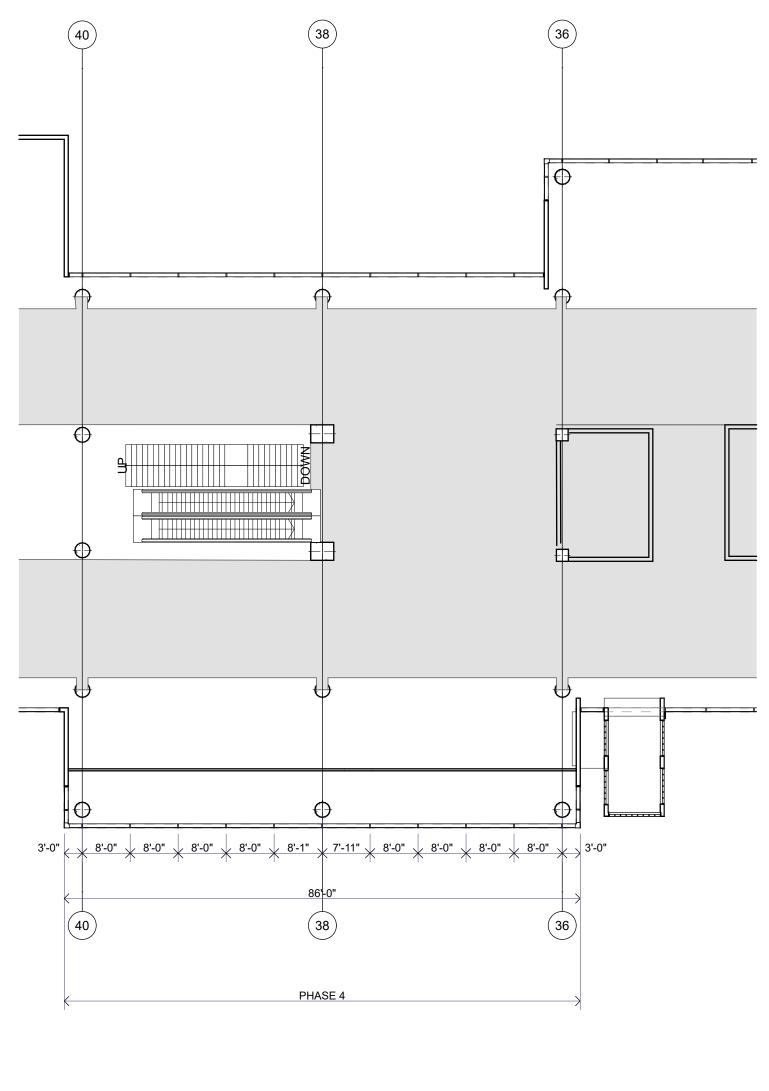
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PROJECT NO.:
201805
2nd & 3rd Floor Phase 4


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A-6


SHEET NO. 23 OF 42





**(40)** 

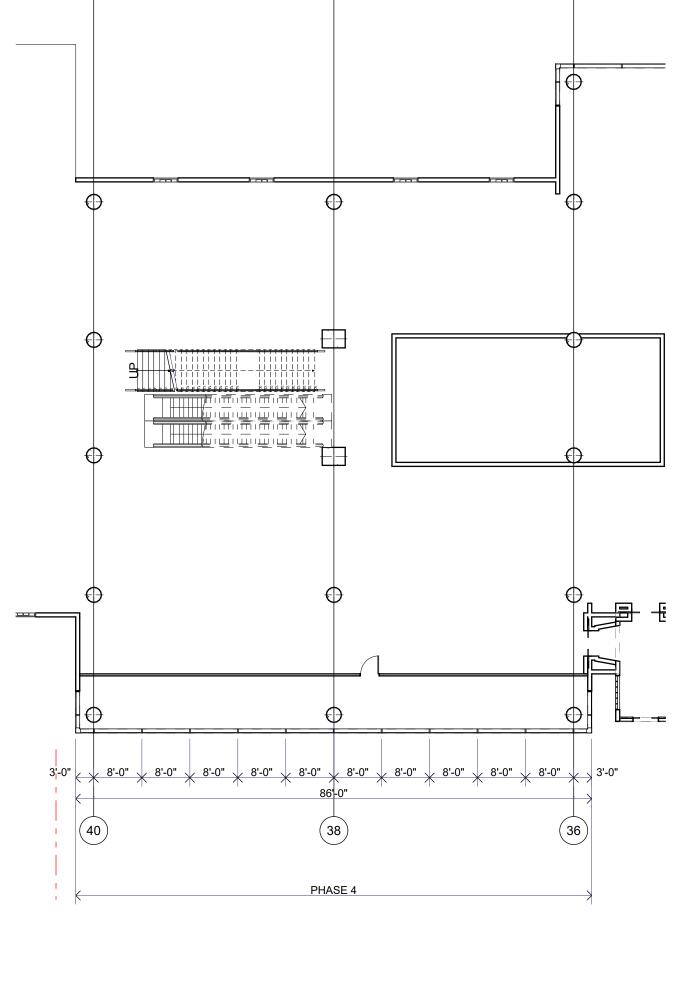Phase 4	Second Floor	1/16" =	1'-0"

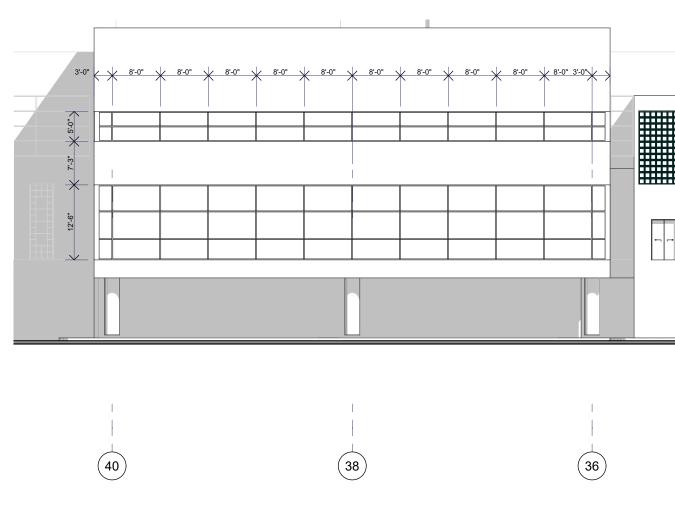

**Partial** 


Third Floor	1/16" =	1'-0"
	Third Floor	Third Floor 1/16" =


KEY PLAN

NORTH

1 & 2

**Building Elevation** 

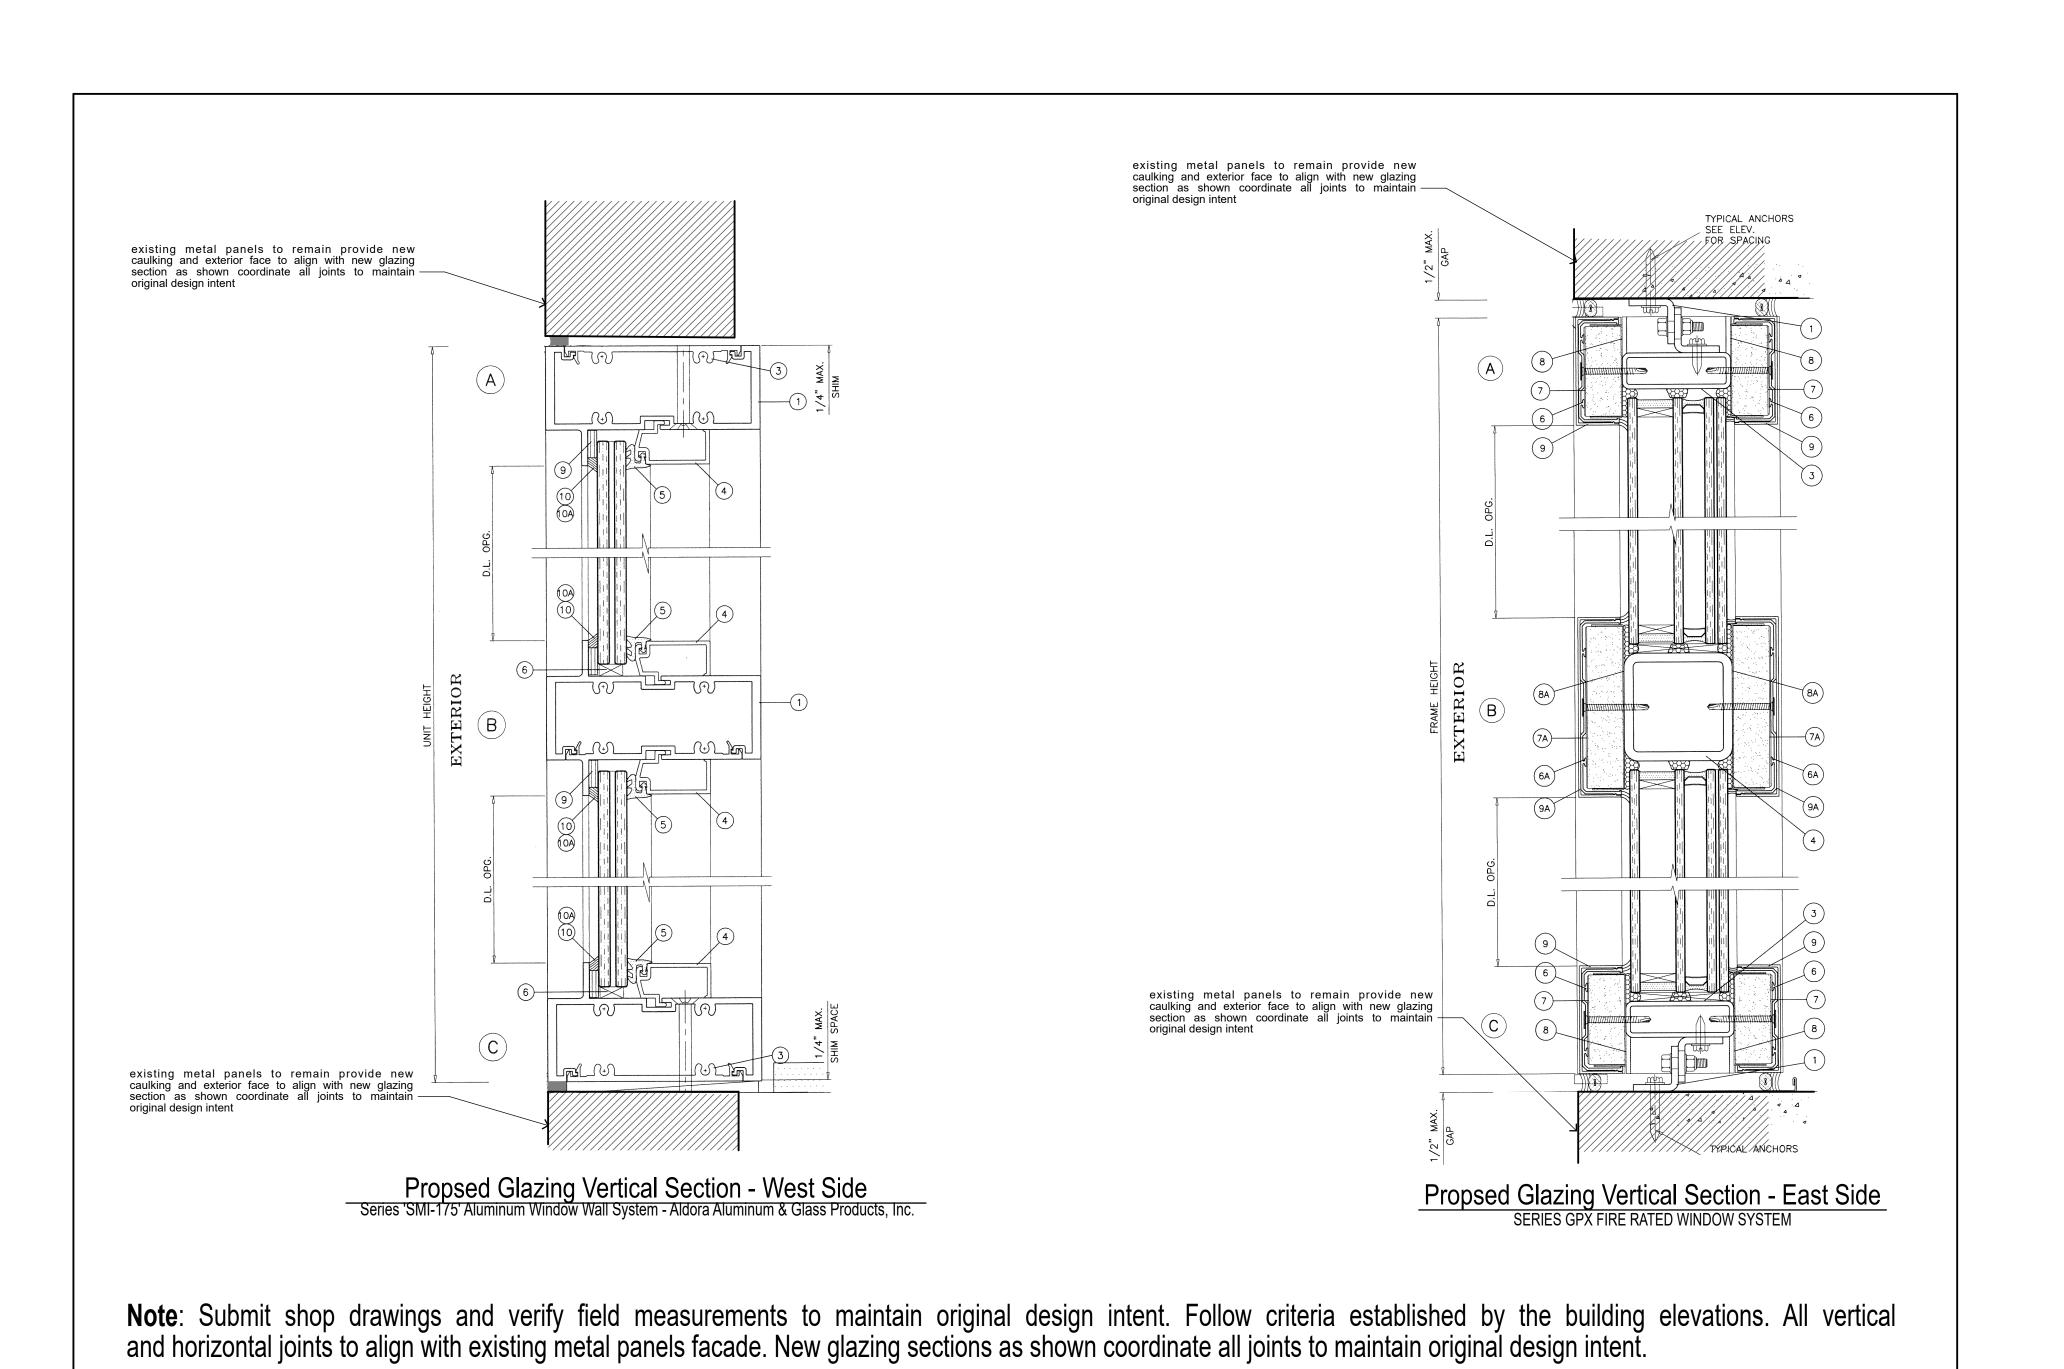

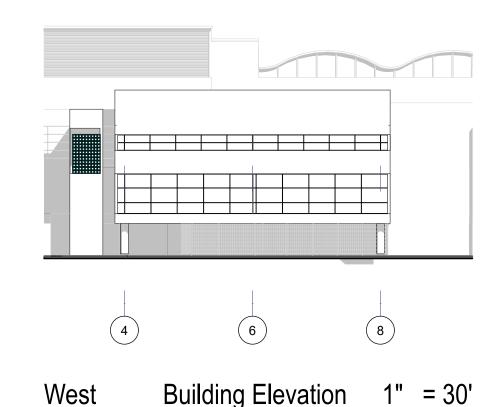

1" = 30'

Phase South Tern.

Rehabilitation - Pring 21 MIAD CIRCLE

'AMI, FLORIDA 33

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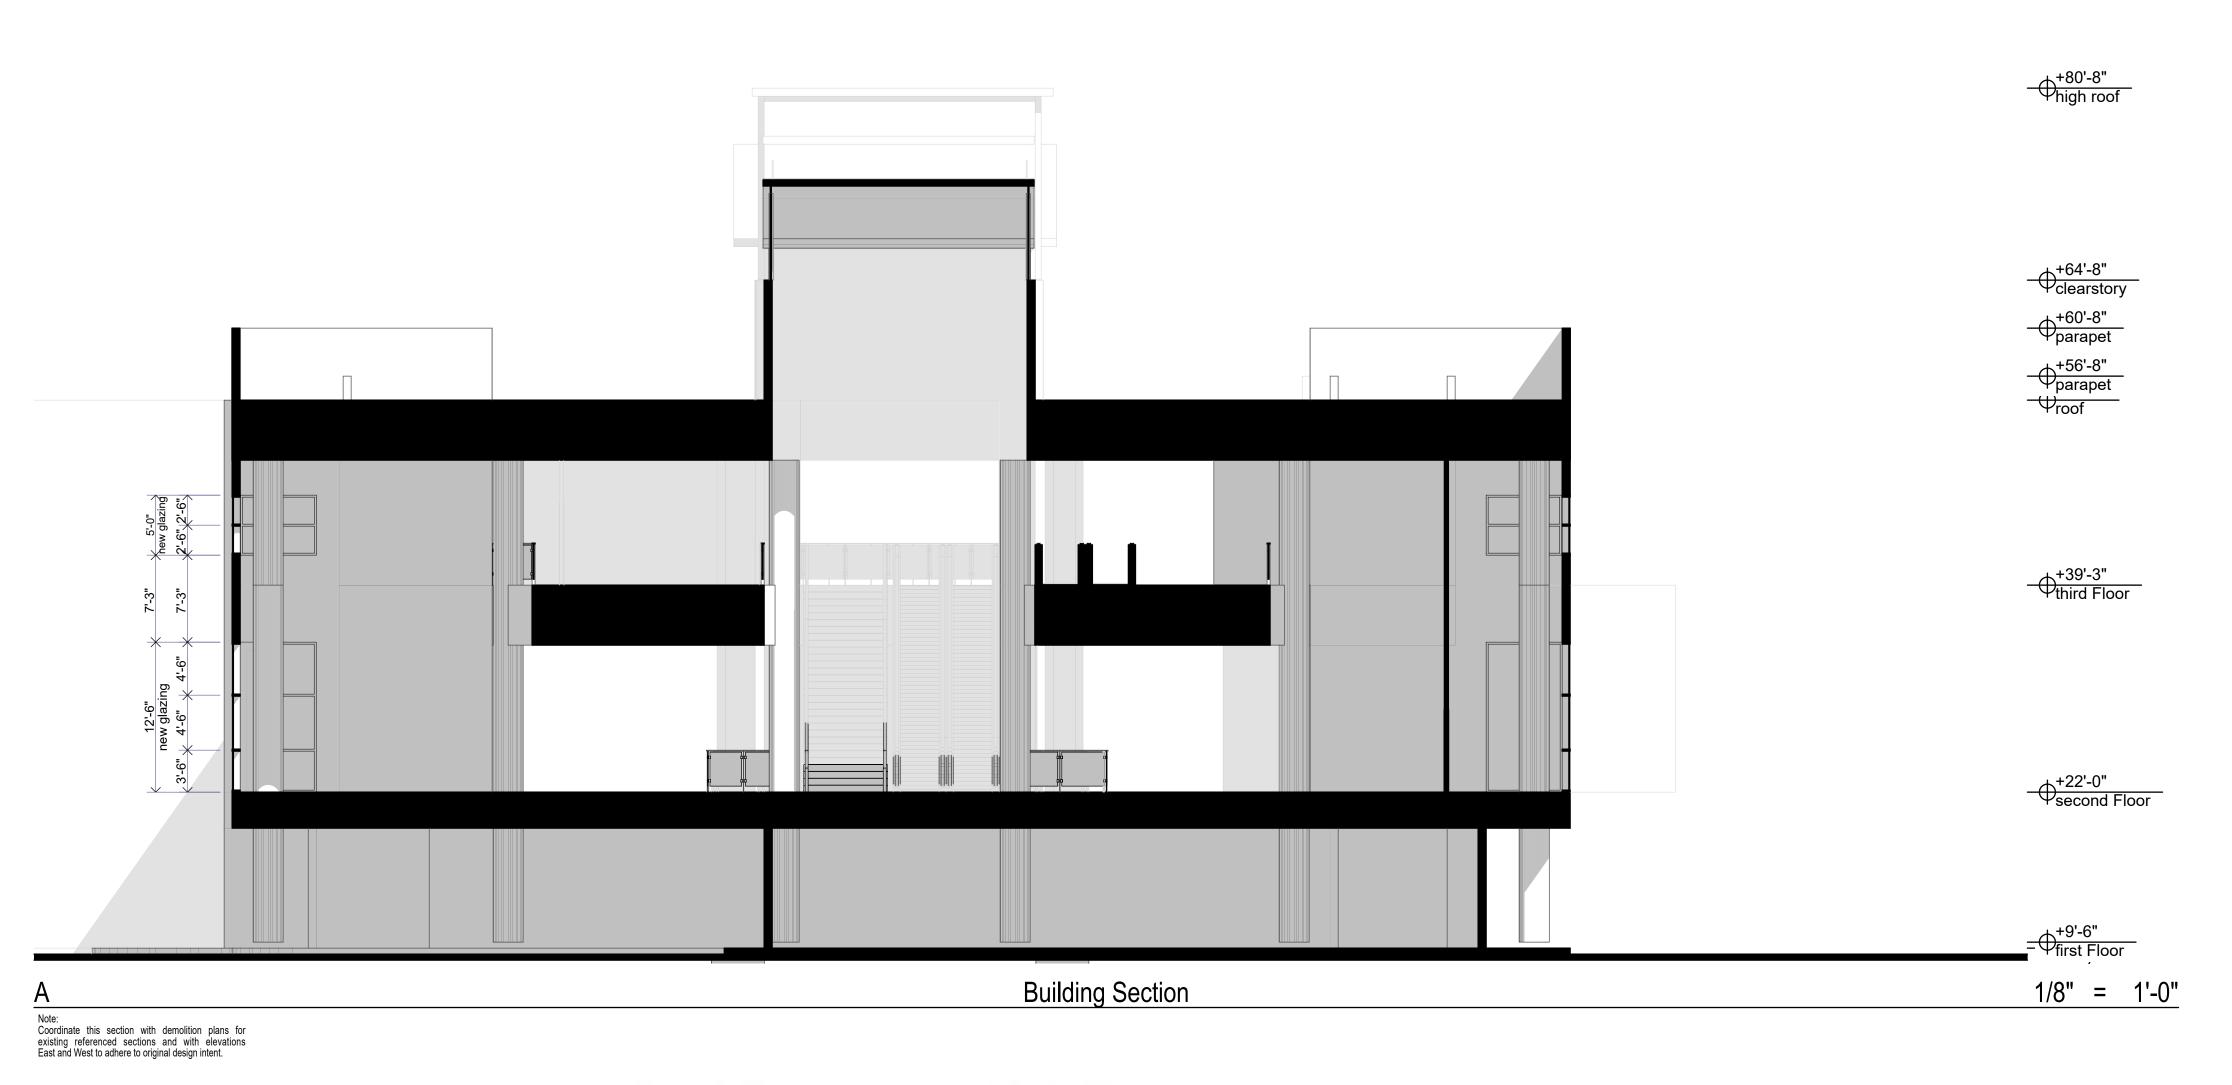
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SHEET NO.: 24 OF 42

**KEY PLAN** NORTH

East





Section View





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Enrique M. Zúñiga, P.E. PE 38883

ARCHITECTS

ENRIQUE M. ZÚÑIGA FLORIDA, P.E. No. 38883

A South Terminal Concoul Rehabilitation - Phase 121 MIAD CIRCLE MIAMI, FLORIDA 33126

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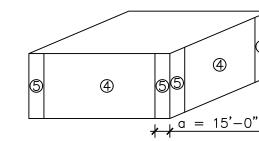
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A-8

SHEET NO. 25 OF 42



SUPERIMPOS	SED	LOADS	
WIND LC	ADS		
ASCE 7-16 V= 186 M. EXPOSURE "C" IMPORTANCE BUILDING ENCLOSED. ZONE A W.	CE= 1	Kd= 0.85	
COMPONENTS 8	& CLAD	DING	
BASIC WIND PRESSURE (ASD LEVE	IL)	56.6 P.S.F.	
LOCATION	ZONE	PRESSURES (	P.S.F.)
ROOF 10 SF	1	-94.8	
	1'	-54.4	24.2
	2	-125	<del>24</del> .2
	3	-170.4	
ROOF 20 SF	1	-68.5	
	1'	-54.4	00.7
	2	-117	22.7
	3	-154.3	
ROOF 50 SF	1	-80.2	
	1'	-54.4	00.7
	2	-106.3	20.7
	3	-133	
ROOF 100 SF	1	-74	
	1'	-54.4	10.0
	2	-98.3	19.2
	3	-117	
WALL 10 SF	4	-59.0	E 4 4
	5	-72.6	54.4
WALL 20 SF	4	-56.6	F0.0
	5	-67.8	52.0
	<del></del>	<del> </del>	<b></b>

WALL 100 SF

#### STRUCTURAL NOTES

#### GENERAL STRUCTURAL NOTES

1. <u>STRUCTURAL CODES & STANDARDS USED:</u> FBC 2020 FLORIDA BUILDING CODE, SEI/ASCE 7-16 AMERICAN SOCIETY OF CIVIL ENGINEERS, MIN DESIGN LOADS FOR BUILDINGS & OTHER STRUCTURES, AISC 14TH EDITION AMERICAN INSTITUTE OF STEEL CONSTRUCTION, MANUAL OF STEEL CONSTRUCTION, AWS D1.1, S2008 STRUCTURAL WELDING CODE.

2.	DESIGN LOAD CRITERIA:  A. BUILDING OCCUPANCY CATEGORY  B. GRAVITY LOADS:	Α
	ROOF LIVE LOAD	30 PSI
	ROOF DESIGN DEAD LOAD	25 PSI
	ROOF COLLATERAL DEAD LOAD	25 PSI
	C. FLOOR:	
	LIVE LOAD	80 PSI
	D. WIND LOADS:	
	ULTIMATE DESIGN WIND SPEED (3-SECOND GUST)	186MPH
	NOMINAL DESIGN WIND SPEED (3-SECOND GUST)	
	RISK CATEGORY	
	WIND EXPOSURE CATEGORY	С

3. <u>MATERIALS:</u> ALL MATERIALS SHALL BE NEW, FREE OF DEFECT, DAMAGE, & CONFORM TO THE FOLLOWING SPECIFICATIONS:

A. STRUCTURAL STEEL:	
<ul> <li>W SHAPES — ASTM A992</li> </ul>	<ul> <li>ANCHOR RODS — F1554 GR.</li> </ul>
<ul> <li>HSS - ASTM A500, GR. B</li> </ul>	<ul> <li>NUTS — ASTM A563</li> </ul>
<ul> <li>PIPE – A53, GR. B</li> </ul>	<ul> <li>WASHERS — ASTM F436</li> </ul>
<ul> <li>ANGLES – ASTM A36</li> </ul>	<ul> <li>THREADED RODS — A36</li> </ul>
<ul> <li>PLATES AND BARS — ASTM A36</li> </ul>	<ul> <li>SHEAR STUDS — A36</li> </ul>
<ul> <li>BOLTS — ASTM A325</li> </ul>	<ul> <li>WELDS — E70XX ELECTRODE</li> </ul>

5. CONTRACTOR SHALL BE PROPERLY-LICENSED, INSURED, EXPERIENCED & KNOWLEDGEABLE IN THE TYPE OF CONSTRUCTION THAT IS TO BE PERFORMED. GC IS RELIED UPON TO ACHIEVE PROPER INSTALLATION OF MATERIALS, WEATHER SEALING, MATERIAL TRANSITIONS,

SEPARATIONS, CONNECTIONS, ETC. 6. CONTRACTOR SHALL USE STRU DWGS IN CONJUNCTION WITH ALL ARCH, PLUM, MECH & ELEC SHTS FOR THE LOCATIONS OF ANY DEPRESSIONS, SLOPES, DRAINS, OUTLETS, RECESSES, OPNGS, SLEEVES, ETC. CONTRACTOR SHALL REVIEW, CHECK, VERIFY ALL PLNS, DIMS & SITE CONDITIONS PRIOR TO CONSTRUCTION, NOTIFY ENGINEER IN-WRITING IMMEDIATELY SHOULD ANY DISCREPANCIES ARISE, CALL (786) 409-5548.

7. CONTRACTOR SHALL BE RESPONSIBLE FOR UPDATING JOB COPIES OF PLANS WITH ANY REVISIONS, FIELD ORDERS, CHANGE ORDERS, OR CLARIFICATION SKETCHES ISSUED BY ENGINEER. ARCHITECT. OWNER OR SUBCONTRACTORS DURING CONSTRUCTION.

PERSONS INCLUDING ADJACENT PROPERTIES, RIGHT-OF-WAY & GENERAL PUBLIC. 9. CONTRACTOR IS RESPONSIBLE FOR DISPOSAL OF ACCUMULATED WATER FROM EXCAVATIONS & DEWATERING OPERATIONS AS TO NOT CAUSE INCONVENIENCE TO THE WORK, DAMAGE TO

8. CONTRACTOR SHALL PROVIDE FOR SAFETY & PREVENTION OF INJURY AT JOBSITE TO ALL

STRU ELEMENTS OR UNREASONABLE HARM TO THE ENVIRONMENT. 10. CONTRACTOR SHALL PROVIDE TEMPORARY BRACING NECESSARY TO ENSURE A STABLE STRUCTURE DURING CONSTRUCTION.

11. ALL WORK PERFORMED SHALL BE COMPLETED TO THE HIGHEST STANDARDS OF CRAFTSMANSHIP BY JOURNEYMEN OF THE RESPECTIVE TRADES. 12. APPROVAL OF ANY WORK BY ANY CITY OR MUNICIPAL INSPECTOR DOES NOT RELIEVE

CONTRACTOR FROM COMPLIANCE WITH STRU DWGS OR CODES MENTIONED ABOVE. 13. GENERAL JOBSITE VISITS BY OWNER, ARCHITECT OR ENGINEER DO NOT CONSTITUTE AN

OFFICIAL INSPECTION OR APPROVAL UNLESS EXPLICITLY MENTIONED IN WRITING. 14. CONTRACTOR SHALL KEEP JOBSITE FREE FROM ACCUMULATION OF WASTE, DEBRIS, RUBBISH, PACKAGING OR OTHERWISE SURPLUS MATERIALS.

15. SHOP DWGS REQUIRING ENGINEERING BY SPECIALTY ENGINEER SHALL COMPLY WITH THE FOLLOWING: A. SPECIALTY ENGINEER SHALL BE FLORIDA LICENSED PROFESSIONAL.

B. SPECIALTY ENGINEER SHALL HAVE AT LEAST FIVE YEARS OF SOLID PROFESSIONAL DESIGN EXPERIENCE IN THE DESIGN & DETAILING OF THE STRUCTURAL COMPONENT AND/OR STRUCTURAL SYSTEM BEING SUBMITTED.

C. SPECIALTY ENGINEER SHALL BE AN EMPLOYEE OR OFFICER OF A FABRICATOR OR COMPANY SUPPLYING COMPONENTS TO THE FABRICATOR. D. SHOP DWGS ARE AN AID FOR FIELD PLACEMENT & SUPERCEDED BY THE STRUCTURAL DWGS. IT SHALL BE THE RESPONSIBILITY OF THE GC TO ENSURE ALL CONSTRUCTION IS IN

FULL AGREEMENT WITH LATEST STRU DWGS. E. CONTRACTOR SHALL SUPPLY ENGINEER WITH COPIES OF SHOP DRAWINGS ACCORDING TO THE ADMINISTRATIVE REQUIREMENTS SET FORTH ON THE COVERSHEET (ENGINEER'S DWGS CANNOT BE USED TO PRODUCE SHOP DWGS WITHOUT PRIOR CONSENT FROM ENGINEER). F. SHOP DWGS REVISED OR RESUBMITTED FOR APPROVAL SHALL BE CLEARLY CLOUDED &

UNLESS NOTED OTHERWISE (UNO). 16. <u>SPECIAL INSPECTIONS:</u> A. SPECIAL INSPECTIONS SHALL BE PERFORMED BY A FLORIDA-LICENSED PROFESSIONAL

ENGINEER & COMPLY WITH FS 553.79. B. SPECIAL INSPECTOR'S INSPECTION LOG MUST BE DISPLAYED IN A PROMINENT LOCATION ON-SITE FOR REF BY BUILDING AUTHORITY & ENGINEER.

NOTED. RE-REVIEW IS LIMITED TO THOSE ITEMS WHICH CAUSED THE RE-SUBMITTAL

C. COMPLETED INSPECTION LOG FORM & SEALED STATEMENT OF COMPLIANCE TO THE BUILDING INSPECTOR SHALL BE SUBMITTED AT FINAL INSPECTION & BEFORE MAKING APPLICATION FOR CERTIFICATE OF OCCUPANCY THE STATEMENT OF COMPLIANCE SHALL STATE: TO THE BEST OF THE SPECIAL INSPECTOR'S KNOWLEDGE, BELIEF AND PROFESSIONAL JUDGMENT THAT PORTIONS OF THE PROJECT OUTLINED FOR THE SPECIAL INSPECTION MEETS WITH THE INTENT OF THE FLORIDA BUILDING CODE AND ARE COMPLETED IN SUBSTANTIAL ACCORDANCE WITH THE APPROVED PLANS.

#### STRUCTURAL STEEL:

48.8

46.4

-61.4

-61.0

-56.6

1. SHALL CONFORM TO AISC "SPECIFICATION FOR THE DESIGN, FABRICATION, AND ERECTION OF STRUCTURAL STEEL FOR BUILDINGS", ENGINEER WITH COMMENTARY. STRUCTURAL STEEL SHOP DWGS SHALL BE SUBMITTED TO ENGINEER FOR REVIEW PRIOR TO FABRICATION.

2. STRU STEEL EXPOSED TO WEATHER SHALL BE HOT DIPPED GALV OR SS INCLUD BOLTS, NUTS & WASHERS. 3. SPLICING OF MEMBERS NOT ALLOWED UNLESS SPECIFIED OR APPROVED BY ARCHITECT

IN-WRITING. 4. FRAMES SHALL BE CARRIED UP TRUE & PLUMB WHILE TEMPORARY BRACING SHALL BE INTRODUCED TO TAKE ALL LOAD TO WHICH THE STRU MAY BE SUBJECTED, INCLUDING EQUIPMENT & OPERATION OF SAME. SUCH BRACING SHALL BE RESPONSIBILITY OF STL

CONTRACTOR & BE IN-PLACE AS LONG AS REQ FOR SAFETY. 5. ALL HSS & PIPE STRU STEEL SHALL BE FILLED WITH 4,000 PSI GROUT. PROVIDE 1/4"DIA WEEP HOLES ON EA SIDE 3" FROM TOP & BTM

6. ALL BOLTS, NUTS & WASHERS SHALL BE NEW, RUST-FREE, WELL LUBRICATED. 7. ALL BOLTS SHALL BE PROVIDED WITH HARDENED WASHERS.

8. BOLT HOLES SHALL BE SHOP DRILLED, CUT, OR PUNCHED PERPENDICULAR TO SURFACE. DO NOT FLAME CUT HOLES OR ENLARGE HOLE BY BURNING. 9. ALL SHOP CONNECTIONS SHALL BE WELDED, UNO.

10. ALL WELDING IS TO BE PERFORMED BY AWS CERTIFIED WELDERS REGISTERED IN THE STATE OF FLORIDA & IN CONFORMANCE TO CURRENT RECOMMENDATIONS OF AISC & AWS. SUBMIT WELDER CERTIFICATES TO ENGINEER FOR APPROVAL BEFORE ANY SHOP FOR FIELD WELDING IS STARTED.

11. ALL WELDED CONNECTIONS SHALL CONFORM TO AWS D1.1, LATEST EDITION. PROVISIONS

SHALL BE MADE FOR FIELD INSPECTION & TESTING OF WELDS. 12. ALL SHOP WELDS SHALL BE TESTED BY NON-DESTRUCTUIVE METHODS & CERTIFIED. ALL

SHOP CONNECTIONS SHALL BE HIGH STRENGTH BOLTED OR WELDED. 13. FIELD CONNECTIONS SHALL BE INSPECTED BY SPECIAL INSPECTOR WHEN REQ BY FBC.

14. FIRE PROOFING OF STRU STEEL SHALL BE INSTALLED AS REQ. 15. STRU STEEL WELDED & BOLTED CONNECTIONS SHALL BE INSPECTED BY SPECIAL INSPECTOR AS PER FBC R4408.5.2.

ANCHOR BOLTS:

INSTALL CONC ANCHORS PER VENDOR INSTALLATION PROCEDURES & RECOMMENDATIONS.

2. CONC ANCHORS SHALL NOT BE INSTALLED IN CRACKED CONC.

3. EMBEDMENT OF ANCHORAGE TO CONC SHALL NOT EXCEED 2/3 OF CONC DEPTH. 4. ANCHORS SHALL BE PRELOADED USING A CALIBRATED MANUALLY OPERATED TORQUE

WRENCH. ANCHORS SHALL BE TORQUED AGAINST THE FIXTURE OR BASE PLATE. 5. ANCHOR THREADS SHALL NOT BE LUBRICATED ON ANY ANCHORS WHICH ARE PRELOADED BY

6. HOLES SHALL BE DRILLED WITHIN 6-DEGREES OF A LINE PERPENDICULAR TO THE SURFACE. EA ANCHOR SHALL HAVE AT LEAST 1 FLAT WASHER. A BEVELED WASHER SHALL BE USED FOR INSTALL OF ANCHOR BOLT GREATER THAN 3-DEGREES FROM PERPENDICULAR.

8. ANCHOR BOLTS SHALL BE EMBEDDED IN GROUTED CELLS OF CMU WALLS. 9. EXCEPT WHERE INDICATED, POST-INSTALLED ANCHORS SHALL CONSIST OF THE FOLLOWING ANCHOR TYPES AS PROVIDED BY HILTI, INC. CONTACT (800) 879-8000 FOR PRODUCT-RELATED QUESTIONS.

A. ANCHORAGE TO CONCRETE I ADHESIVE ANCHORS FOR CRACKED & UNCRACKED CONC WITH SAFE SET TECHNOLOGY: HILTI HIT-HY 200 ADHESIVE ANCHORING SYSTEM INSTALLED USING HILTI HOLLOW DRILL BIT (TE-CD OR TE-YD) WITH HAS-E THREADED ROD OR DEFORMED REBAR PER ESR-3187 FOR FAST CURE APPLICATIONS.

• HILTI HIT-HY 200 ADHESIVE ANCHORING SYSTEM WITH THE HILTI HIT-Z ROD PER ESR-3187 FOR FAST CURE APPLICATIONS. II ADHESIVE ANCHORS FOR CRACKED & UNCRACKED CONCRETE WITH STND CLEANING

PROCEDURES USE: • HILTI HIT-HY 200 ADHESIVE ANCHORING SYSTEM WITH HAS-E THREADED ROD OR DEFORMED REBAR PER ESR-3187 FOR FAST CURE APPLICATIONS.

• HILTI HIT-RE 500-SD EPOXY ADHESIVE ANCHORING SYSTEM WITH HAS-E THREADED ROD OR DEFORMED REBAR PER ICC ESR-2322 FOR SLOW CURE

APPLICATIONS III MEDIUM DUTY MECHANICAL ANCHORS FOR CRACKED AND UNCRACKED CONCRETE USE:

 HILTI KWIK HUS EZ AND KWIK HUS EZ-I SCREW ANCHORS PER ICC ESR-3027 HILTI KWIK BOLT-TZ EXPANSION ANCHORS PER ICC ESR-1917

 HILTI KWIK BOLT 3 EXPANSION ANCHORS (UNCRACKED CONCRETE ONLY) PER ICC ESR-2302

IV HEAVY DUTY MECHANICAL ANCHORS FOR CRACKED AND UNCRACKED CONCRETE USE: HILTI HDA UNDERCUT ANCHORS PER ICC ESR 1546

• HILTI HSL-3 EXPANSION ANCHORS PER ICC ESR 1545

V ANCHORAGE TO SOLID GROUTED MASONRY a. ADHESIVE ANCHORS USE:

- HILTI HIT-HY 70 MASONRY ADHESIVE ANCHORING SYSTEM (ICC PENDING). - STEEL ANCHOR ELEMENT SHALL BE HILTI HAS-E CONTINUOUSLY THREADED ROD OR CONTINUOUSLY DEFORMED STEEL REBAR

b. MECHANICAL ANCHORS USE:

- HILTI KWIK BOLT-3 EXPANSION ANCHORS PER ICC ESR 1385 10. ANCHOR CAPACITY BASED ON TECH DATA PUBLISHED BY HILTI OR SUCH OTHER METHOD AS APPROVED BY ENGINEER. SUBSTITUTION REQUESTS FOR ALTERNATE PRODUCTS MUST BE APPROVED IN-WRITING PRIOR TO USE. CONTRACTOR SHALL PROVIDE CALCS DEMONSTRATING SUBSTITUTED PRODUCTS. SUBSTITUTIONS WILL BE EVALUATED BY HAVING AN ICC ESR SHOWING COMPLIANCE WITH RELEVANT BUILDING CODE FOR SEISMIC USES, LOAD RESISTANCE, INSTALLATION CATEGORY & AVAILABILITY OF COMPREHENSIVE INSTALLATION INSTRUCTIONS. ADHESIVE ANCHOR EVALUATION MUST CONSIDER CREEP, IN-SERVICE TEMP & INSTALL TEMP.

11. INSTALL ANCHORS PER MANF INSTRUCTIONS, AS INCLUDED IN THE ANCHOR PACKAGING. 12. OVERHEAD ADHESIVE ANCHORS MUST BE INSTALLED USING THE HILTI PROFI SYSTEM. 13. CONTRACTOR SHALL ARRANGE ANCHOR MANF'S REPRESENTATIVE TO PROVIDE ON-SITE

INSTALLATION TRAINING IF INSTALLERS ARE NOT ALREADY PROPERLY TRAINED. 14. ANCHOR CAPACITY IS DEPENDENT UPON SPACING BTW ADJACENT ANCHORS & PROXIMITY OF ANCHORS TO EDGES. INSTALL ANCHORS PER SPACING & EDGE CLEARANCES INDICATED ON

15. EXIST REINF BARS IN CONC STRUCTURE MAY CONFLICT WITH SPECIFIC ANCHOR LOCATIONS. UNLESS NOTED ON DWGS THAT THE BARS CAN BE CUT, CONTRACTOR SHALL REVIEW EXIST STRU DWGS & UNDERTAKE TO LOCATE THE POSITION OF REINF BARS AT THE LOCATIONS OF THE CONCE ANCHORS, BY HILTI FERROSCAN, GPR, X-RAY, CHIPPING OR OTHER MEANS.

#### FINAL COATING/FINISHING SURFACES TO BE COATED SHALL BE CLEAN, FREE OF DIRT, GREASE, OIL, MOISTURE &

FOREIGN MATTER. 2. CLEANING SHALL BE PERFORMED AFTER ASSEMBLY OF EA COMPONENT HAS BEEN

3. PROVIDE 1- COAT OF RUST INHIBITING PAINT MIN 3 MIL DRY FILM THICKNESS ON ALL STRU STEEL EXCEPT STAINLESS STEEL, GALVANIZED STEEL OR <u>SURFACES</u> <u>EMBEDDED</u> <u>OR</u> <u>IN</u>

CONTACT WITH CONC SHALL NOT RECEIVE ANY TYPE OF COATING. JOINTS, CREVICES, SEAMS, EDGES, ETC. SHALL BE CAULKED PRIOR TO TOP-COATING TO PREVENT COLLECTION OF MOISTURE. 5. PRIMER & PAINT SHALL BE APPLIED TO ALL SURFACES EXPOSED TO WEATHER WITH EXT

PAINT. UNO. 6. PRIOR TO APPLICATION, COLOR OF COATINGS SHALL BE DETERMINED BY OWNER OR DELEGATED INDIVIDUAL. PRIMER & TOP COAT SHOULD HAVE A DIFFERENCE IN COLOR OR TINT TO VERIFY COVERAGE.

THE INFORMATION CONTAINED HEREIN IS RELIABLE, GENERALLY ACCURATE FOR THE PURPOSE INTENDED, AND IS IN ACCORDANCE WITH APPLICABLE INDUSTRY CODES AND STANDARDS. ONLY STAMPED & SIGNED COPIES SHALL BE CONSIDERED FULLY-ENGINEERED PLANS AND/OR PUBLICATIONS. NO WORK SHALL BE PERFORMED UNTIL FINAL APPROVAL IS OBTAINED BY THE

#### **ABBREVIATIONS**

BUILDING AUTHORITY.


AFF	ABOVE FINISHED FLOOR	EA	EACH	MIN	MINIMUM
ALT	ALTERNATE	E.F.	EACH FACE	OC	ON CENTER
BD	BOARD	ELEV	ELEVATION	REF	REFERENCE
BM	BEAM	EMB	EMBEDMENT	REQ	REQUIRED
BOC	BOT OF CONC	E.W.	EACH WAY	SCHED	SCHEDULE
BOS	BOT OF STEEL	EXIST	EXISTING	STRU	STRUCTURAL
BTM	BOTTOM	FBC	FLORIDA BUILDING CODE	T&B	TOP & BTM
CANT	CANTILEVER	FFE	FINISHED FLOOR ELEVATION	T&S	TEMP & SHRINKAGE
CLR	CLEAR	FURR	FURRING	TB	TIE BEAM
CHAMF	CHAMFER	GA	GAUGE	TE	THICKENED EDGE
C.J.	CONTROL JOINT	GB	GRADE BEAM	TOC	TOP OF CONC
COL	COLUMN	GYP	GYPSUM	TOS	TOP OF STEEL
CONC	CONCRETE	JT	JOINT	TYP	TYPICAL
CONT	CONTINUOUS	MANF	MANUFACTURER	UNO	UNLESS NOTED OTHERWISE
DTL	DETAIL	MAX	MAXIMUM	WD	WOOD





ENGINEERS LLC **ENGINEERS • PLANNERS** 13944 S.W. 8 Street, Suite 21 Miami, Florida 33184 (786) 409-5548 FL Certificate of Autorization No.: 30247 Enrique M. Zúñiga, P.E. PE 3888



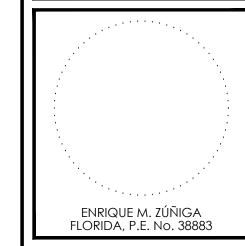

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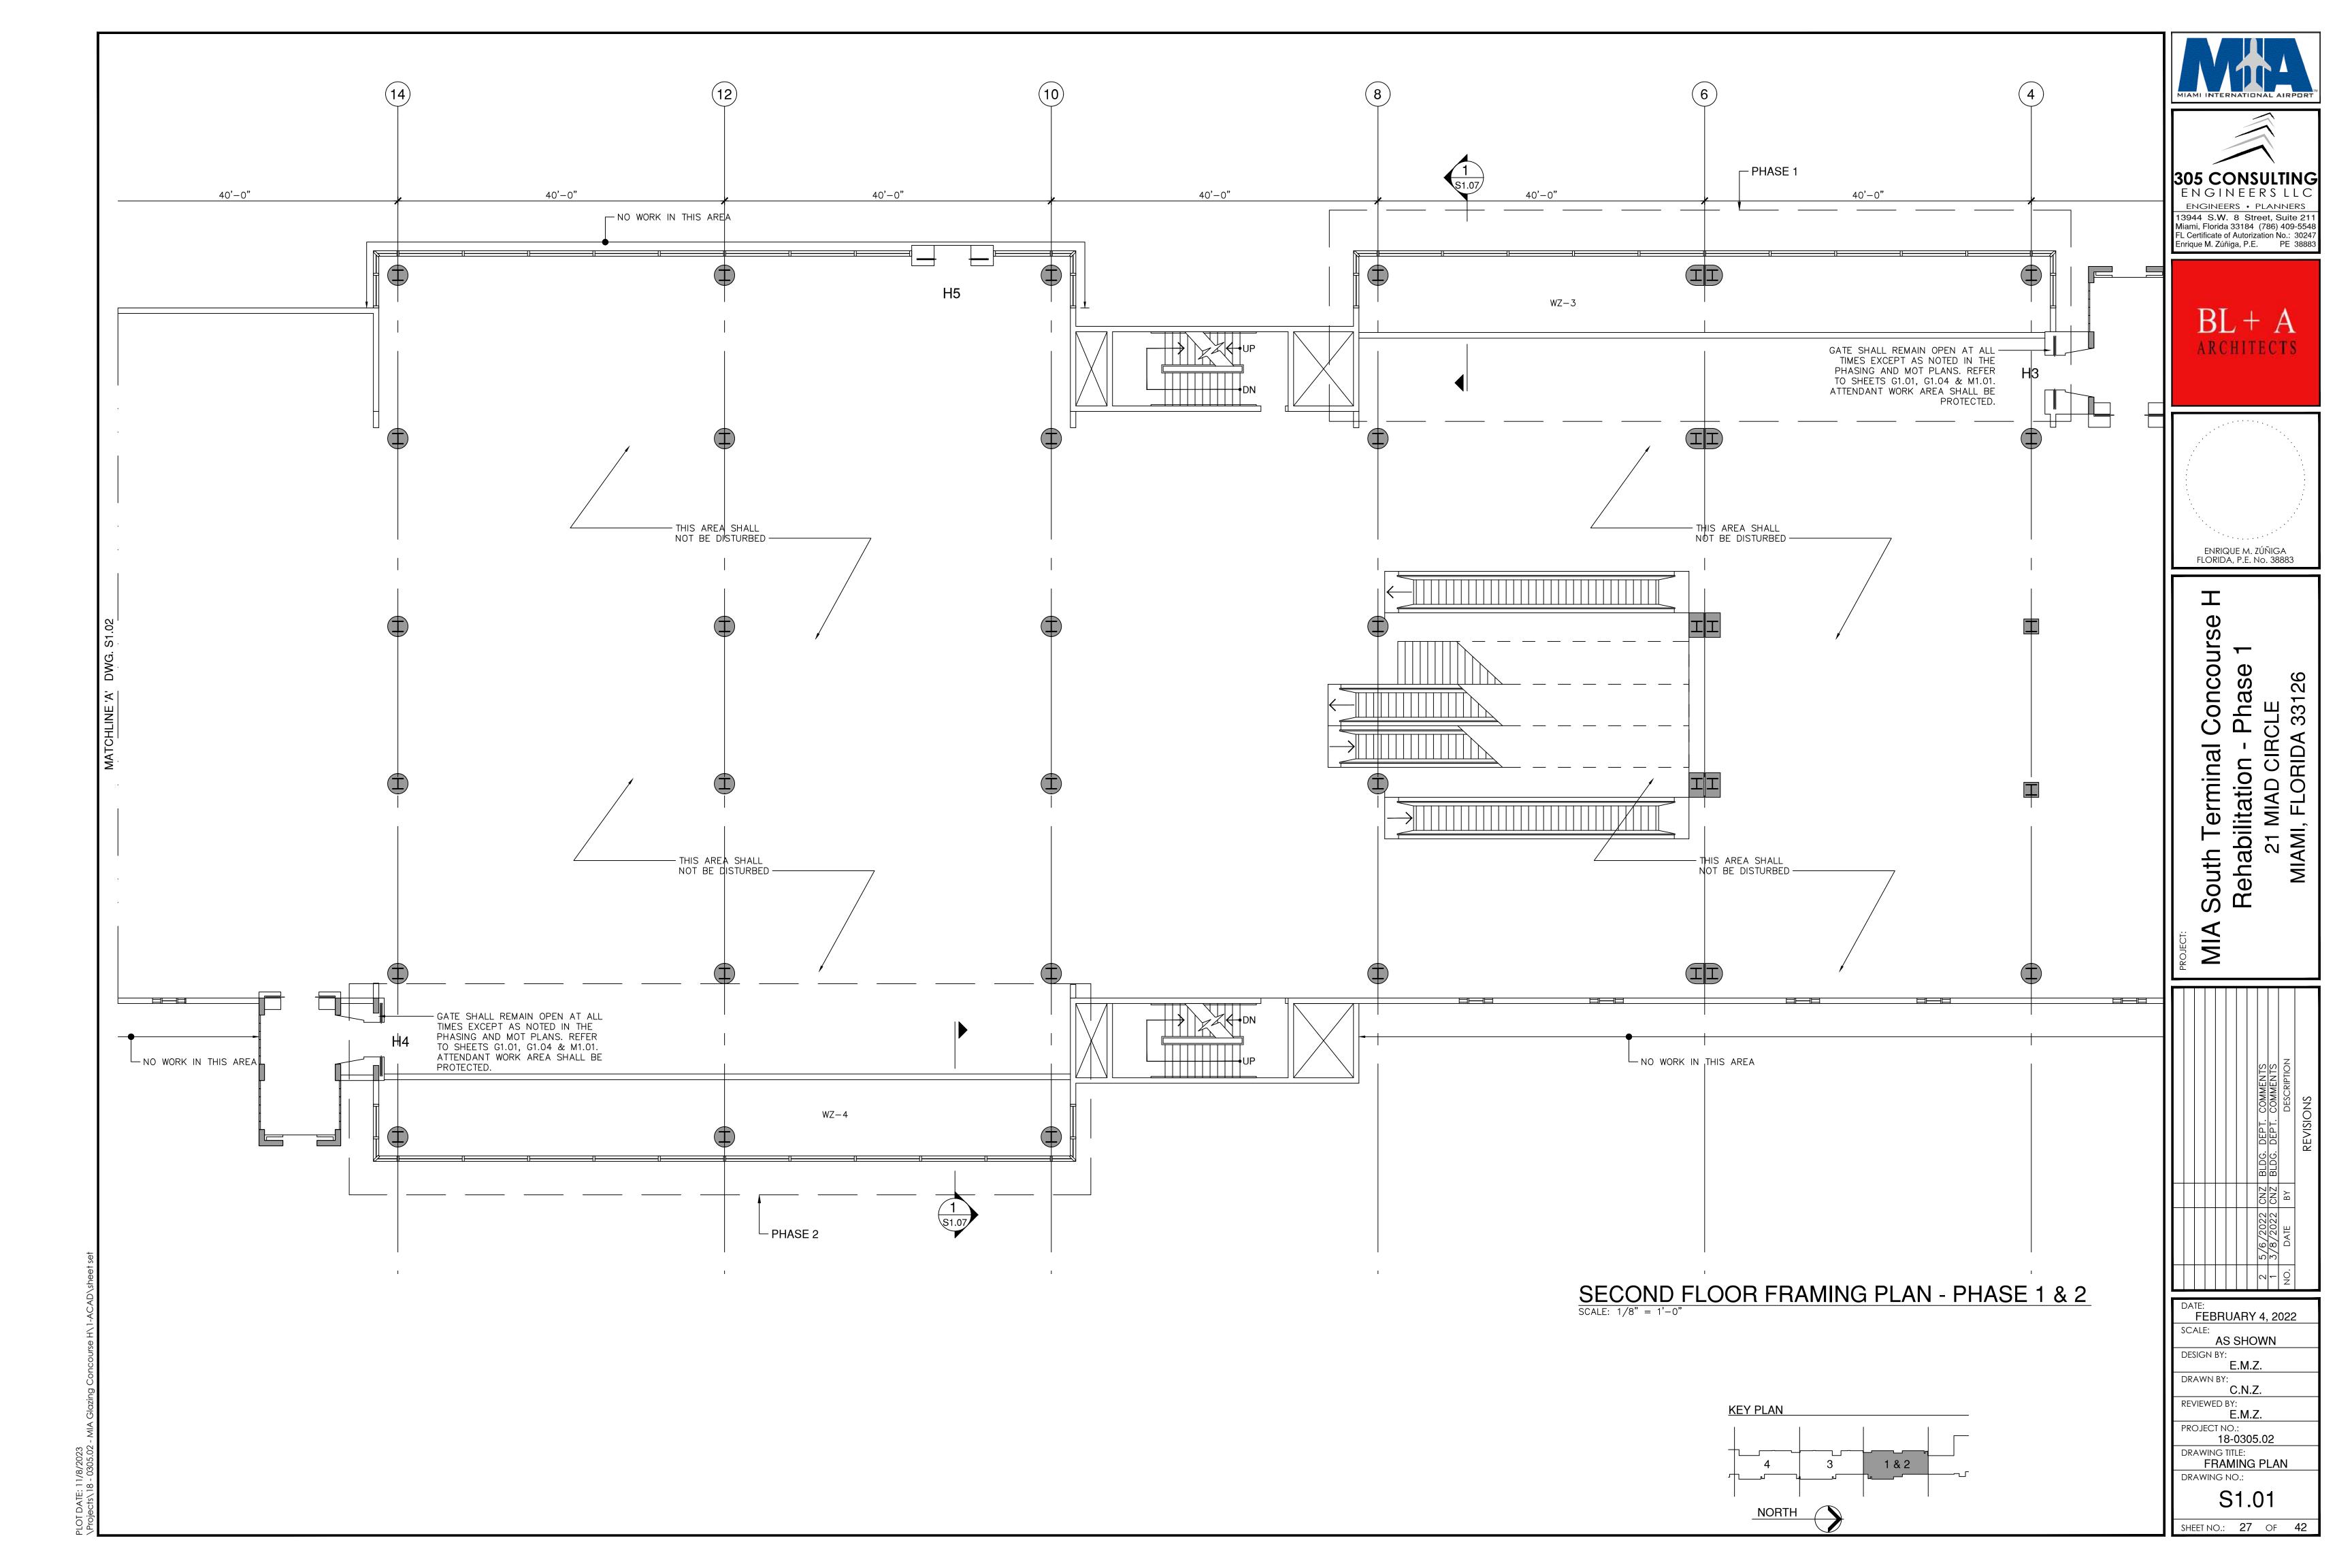
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				5/6/2022	3/8/2022 CNZ	DATE	
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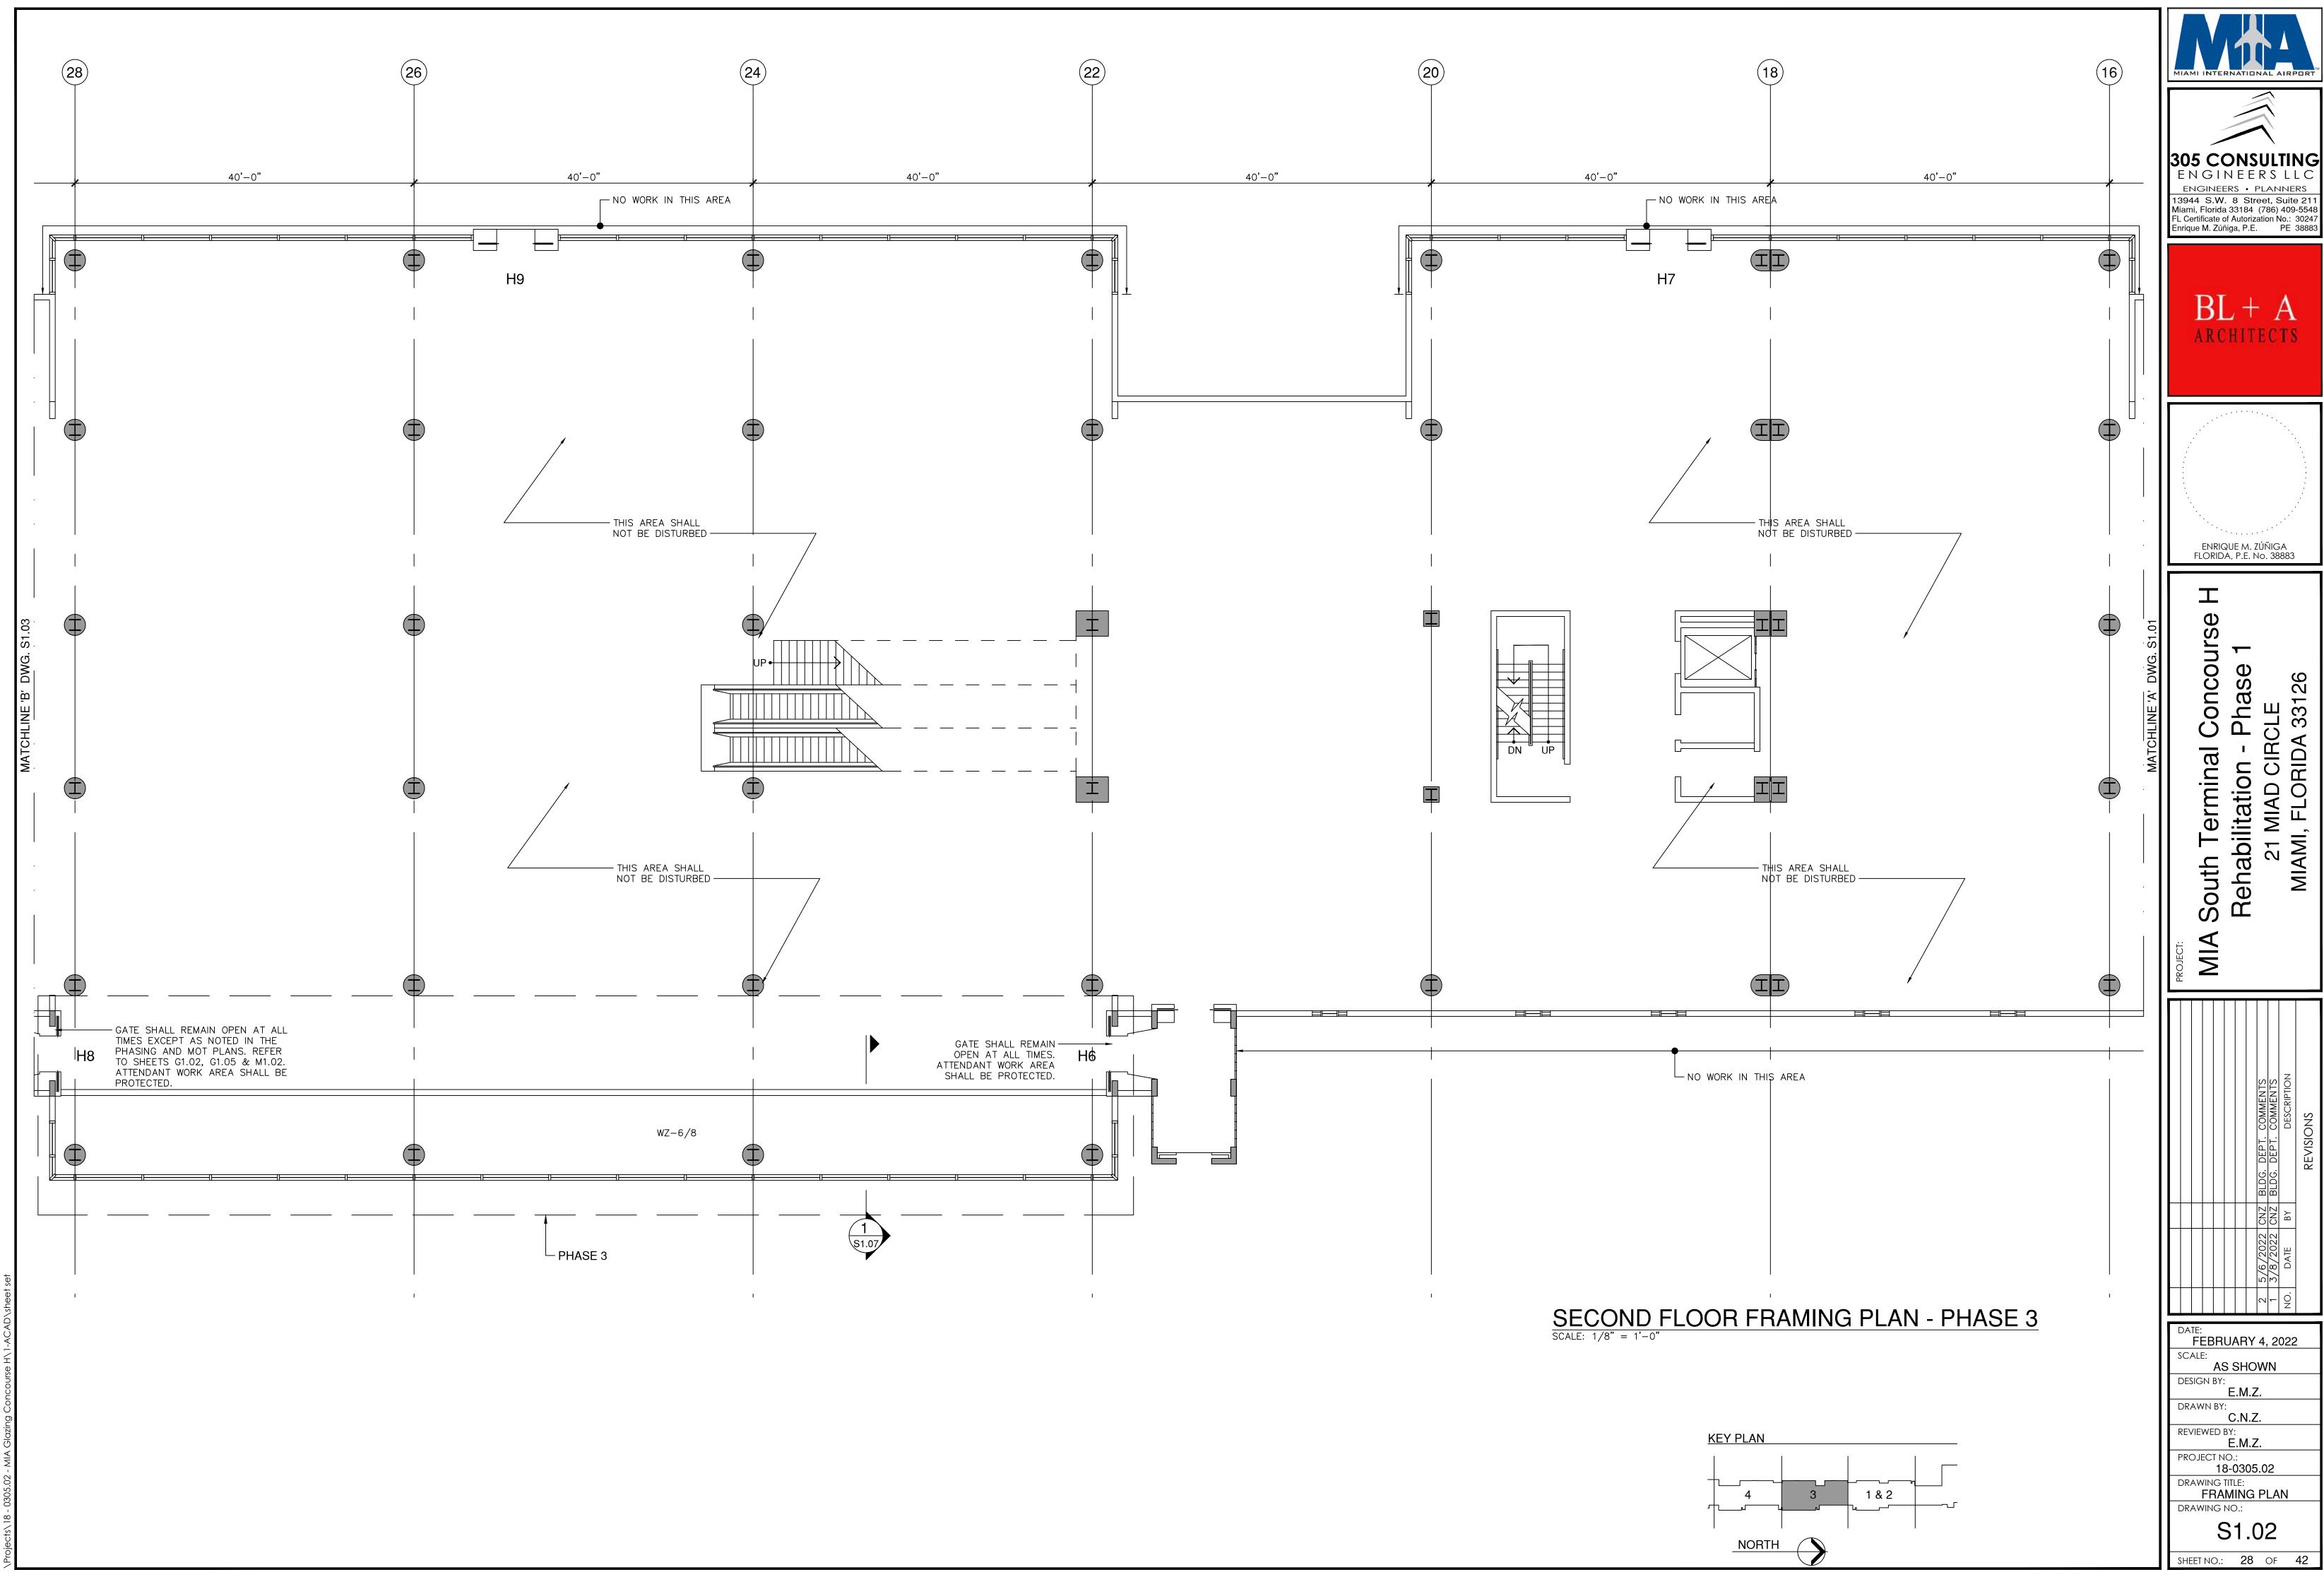
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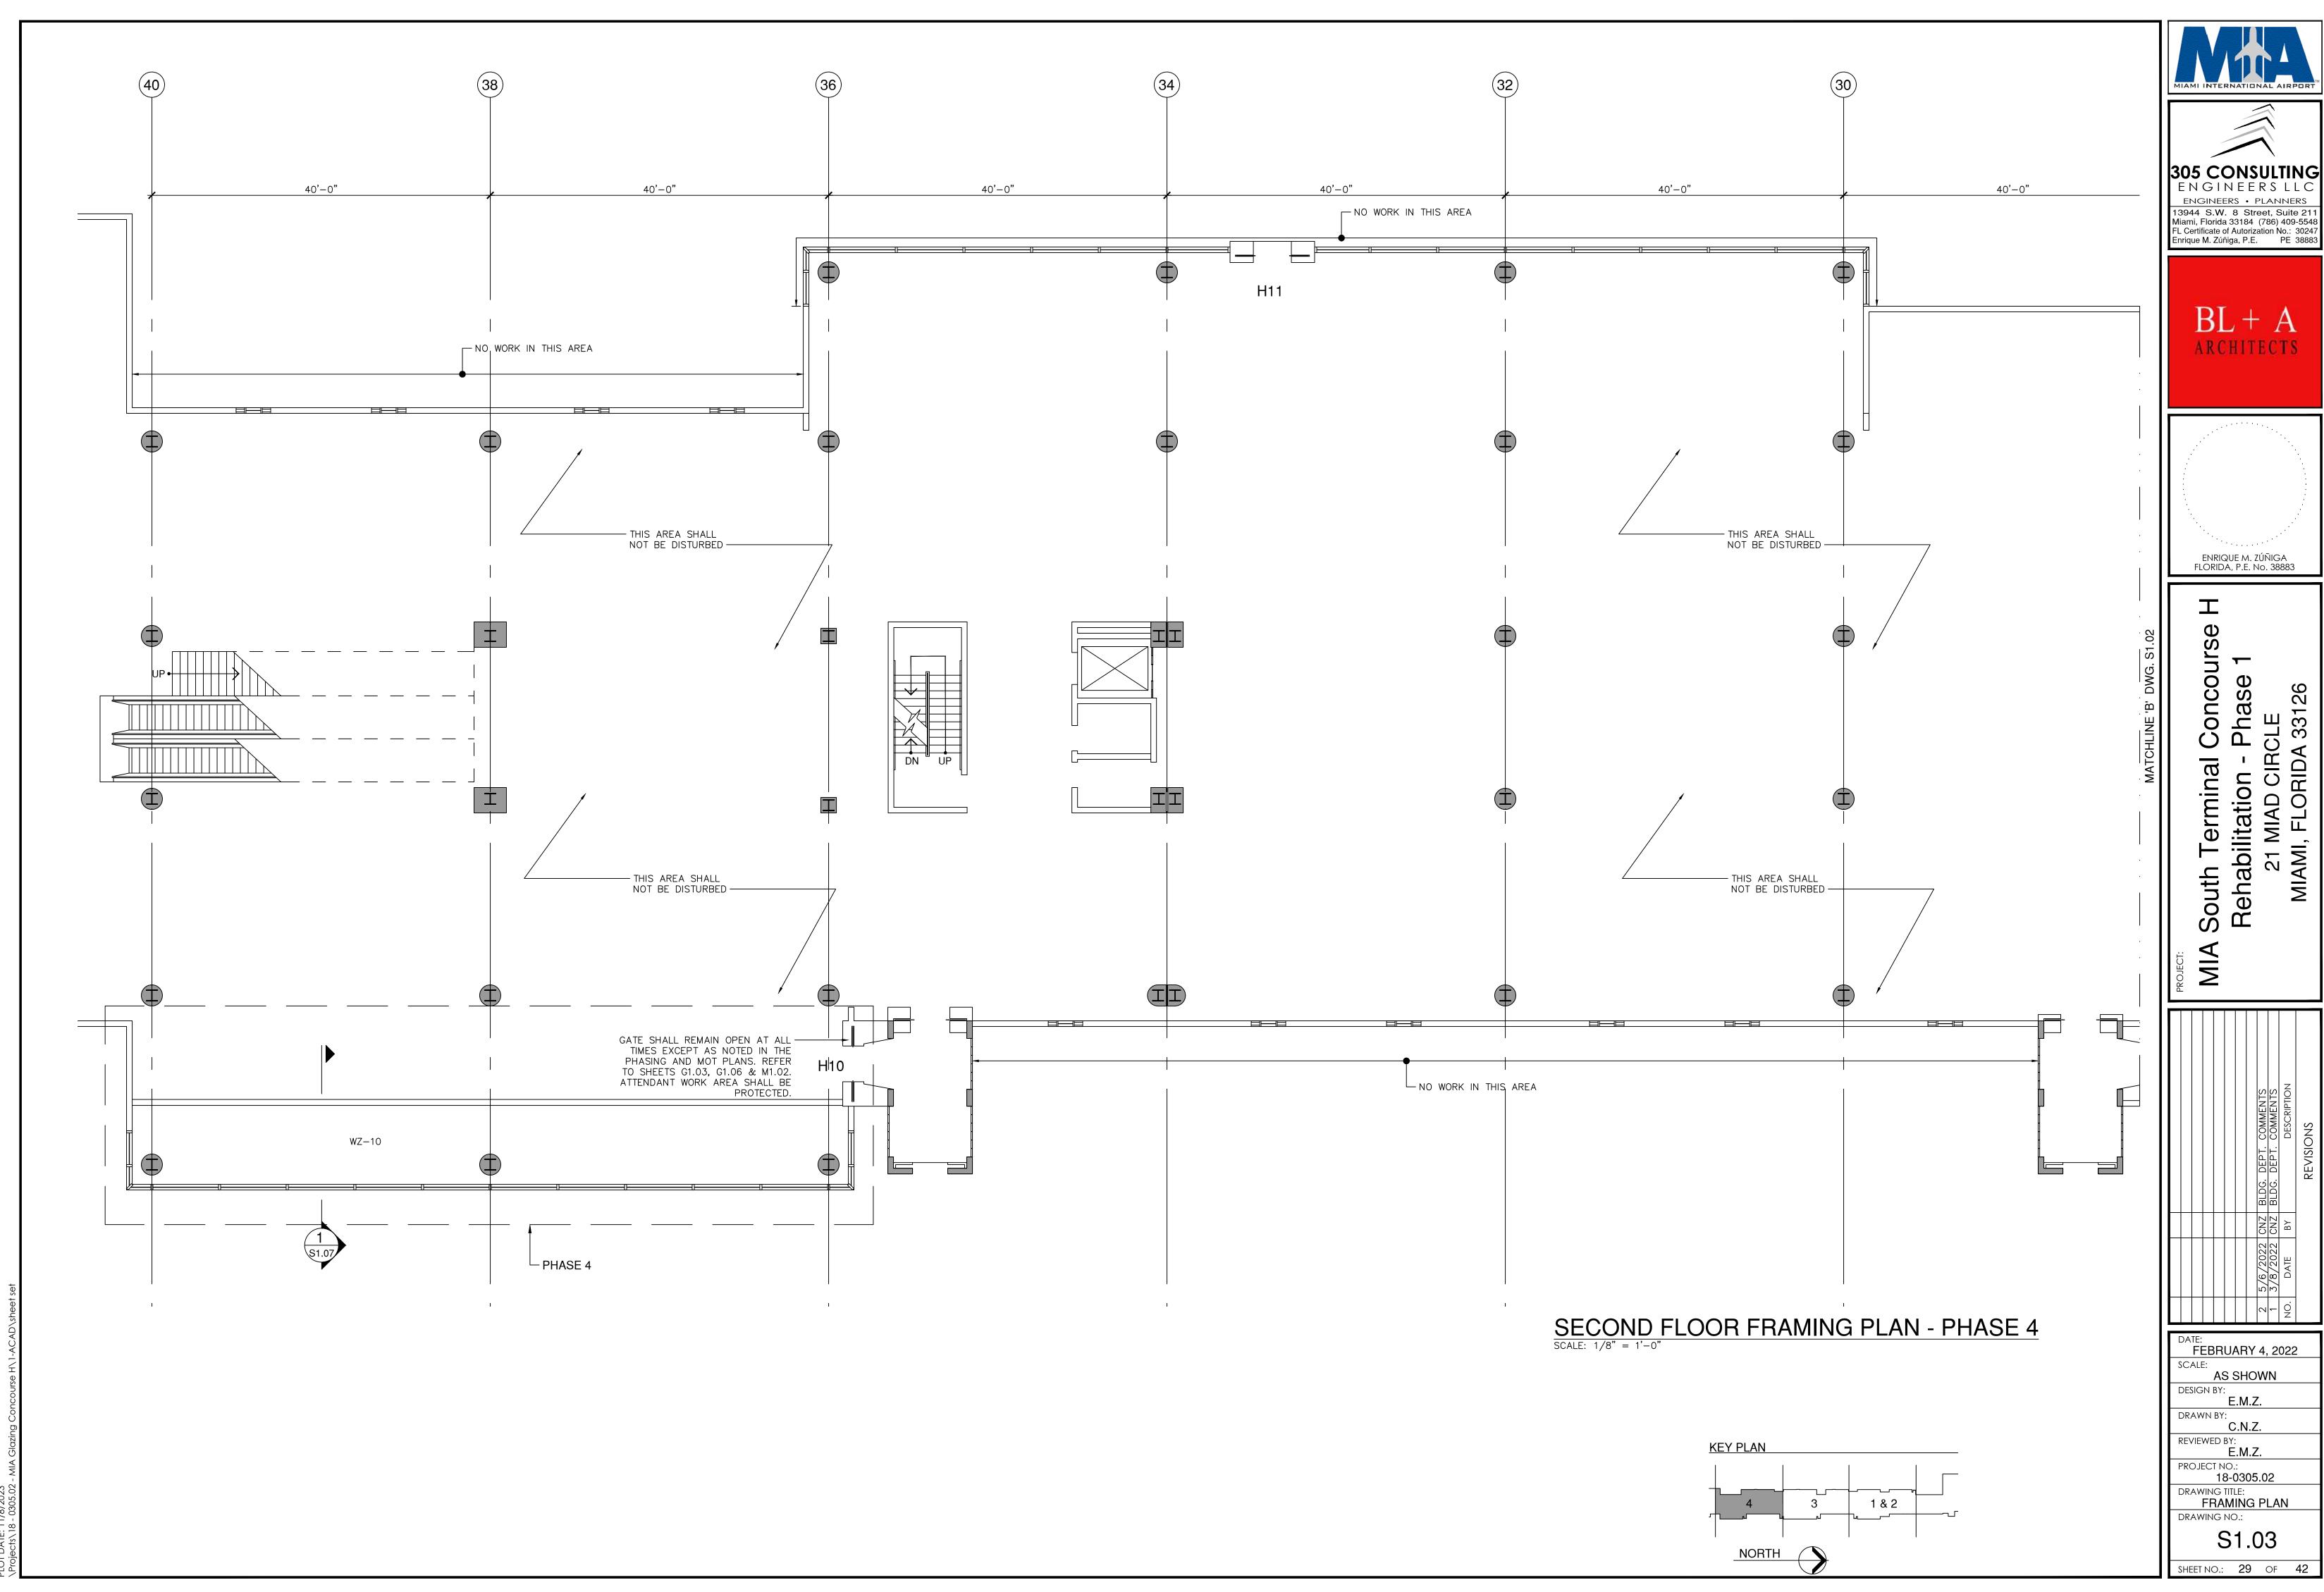
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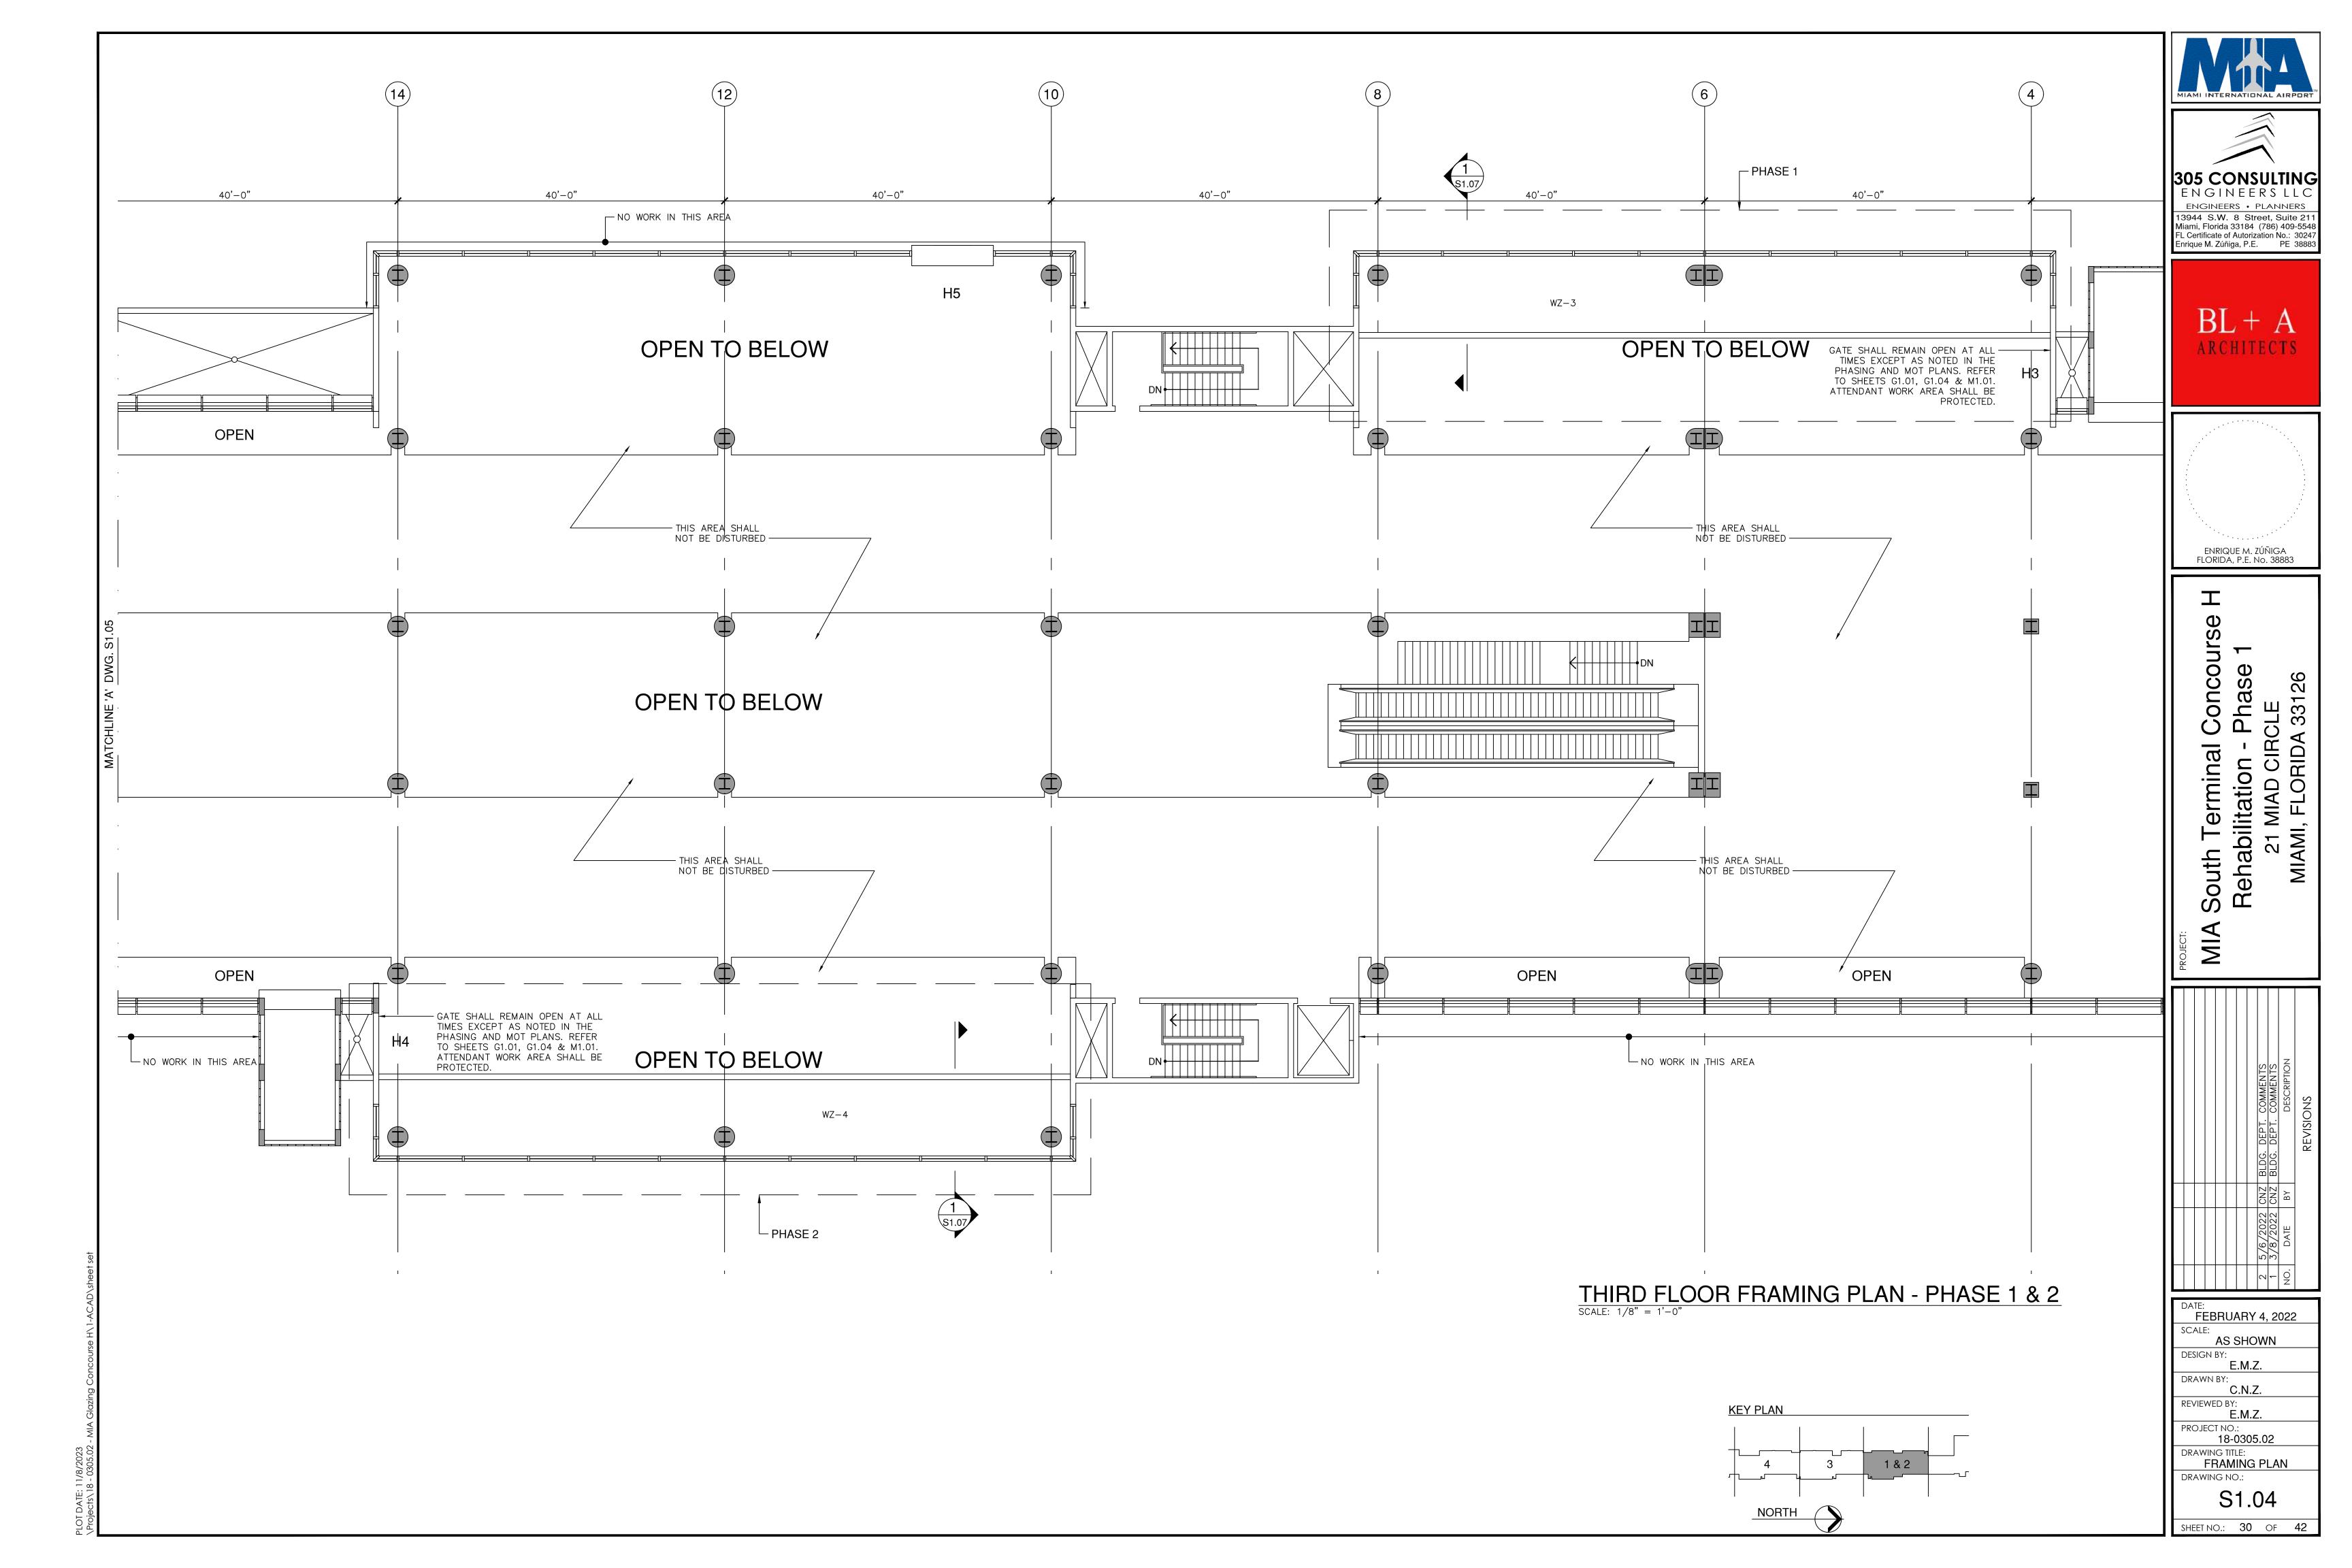
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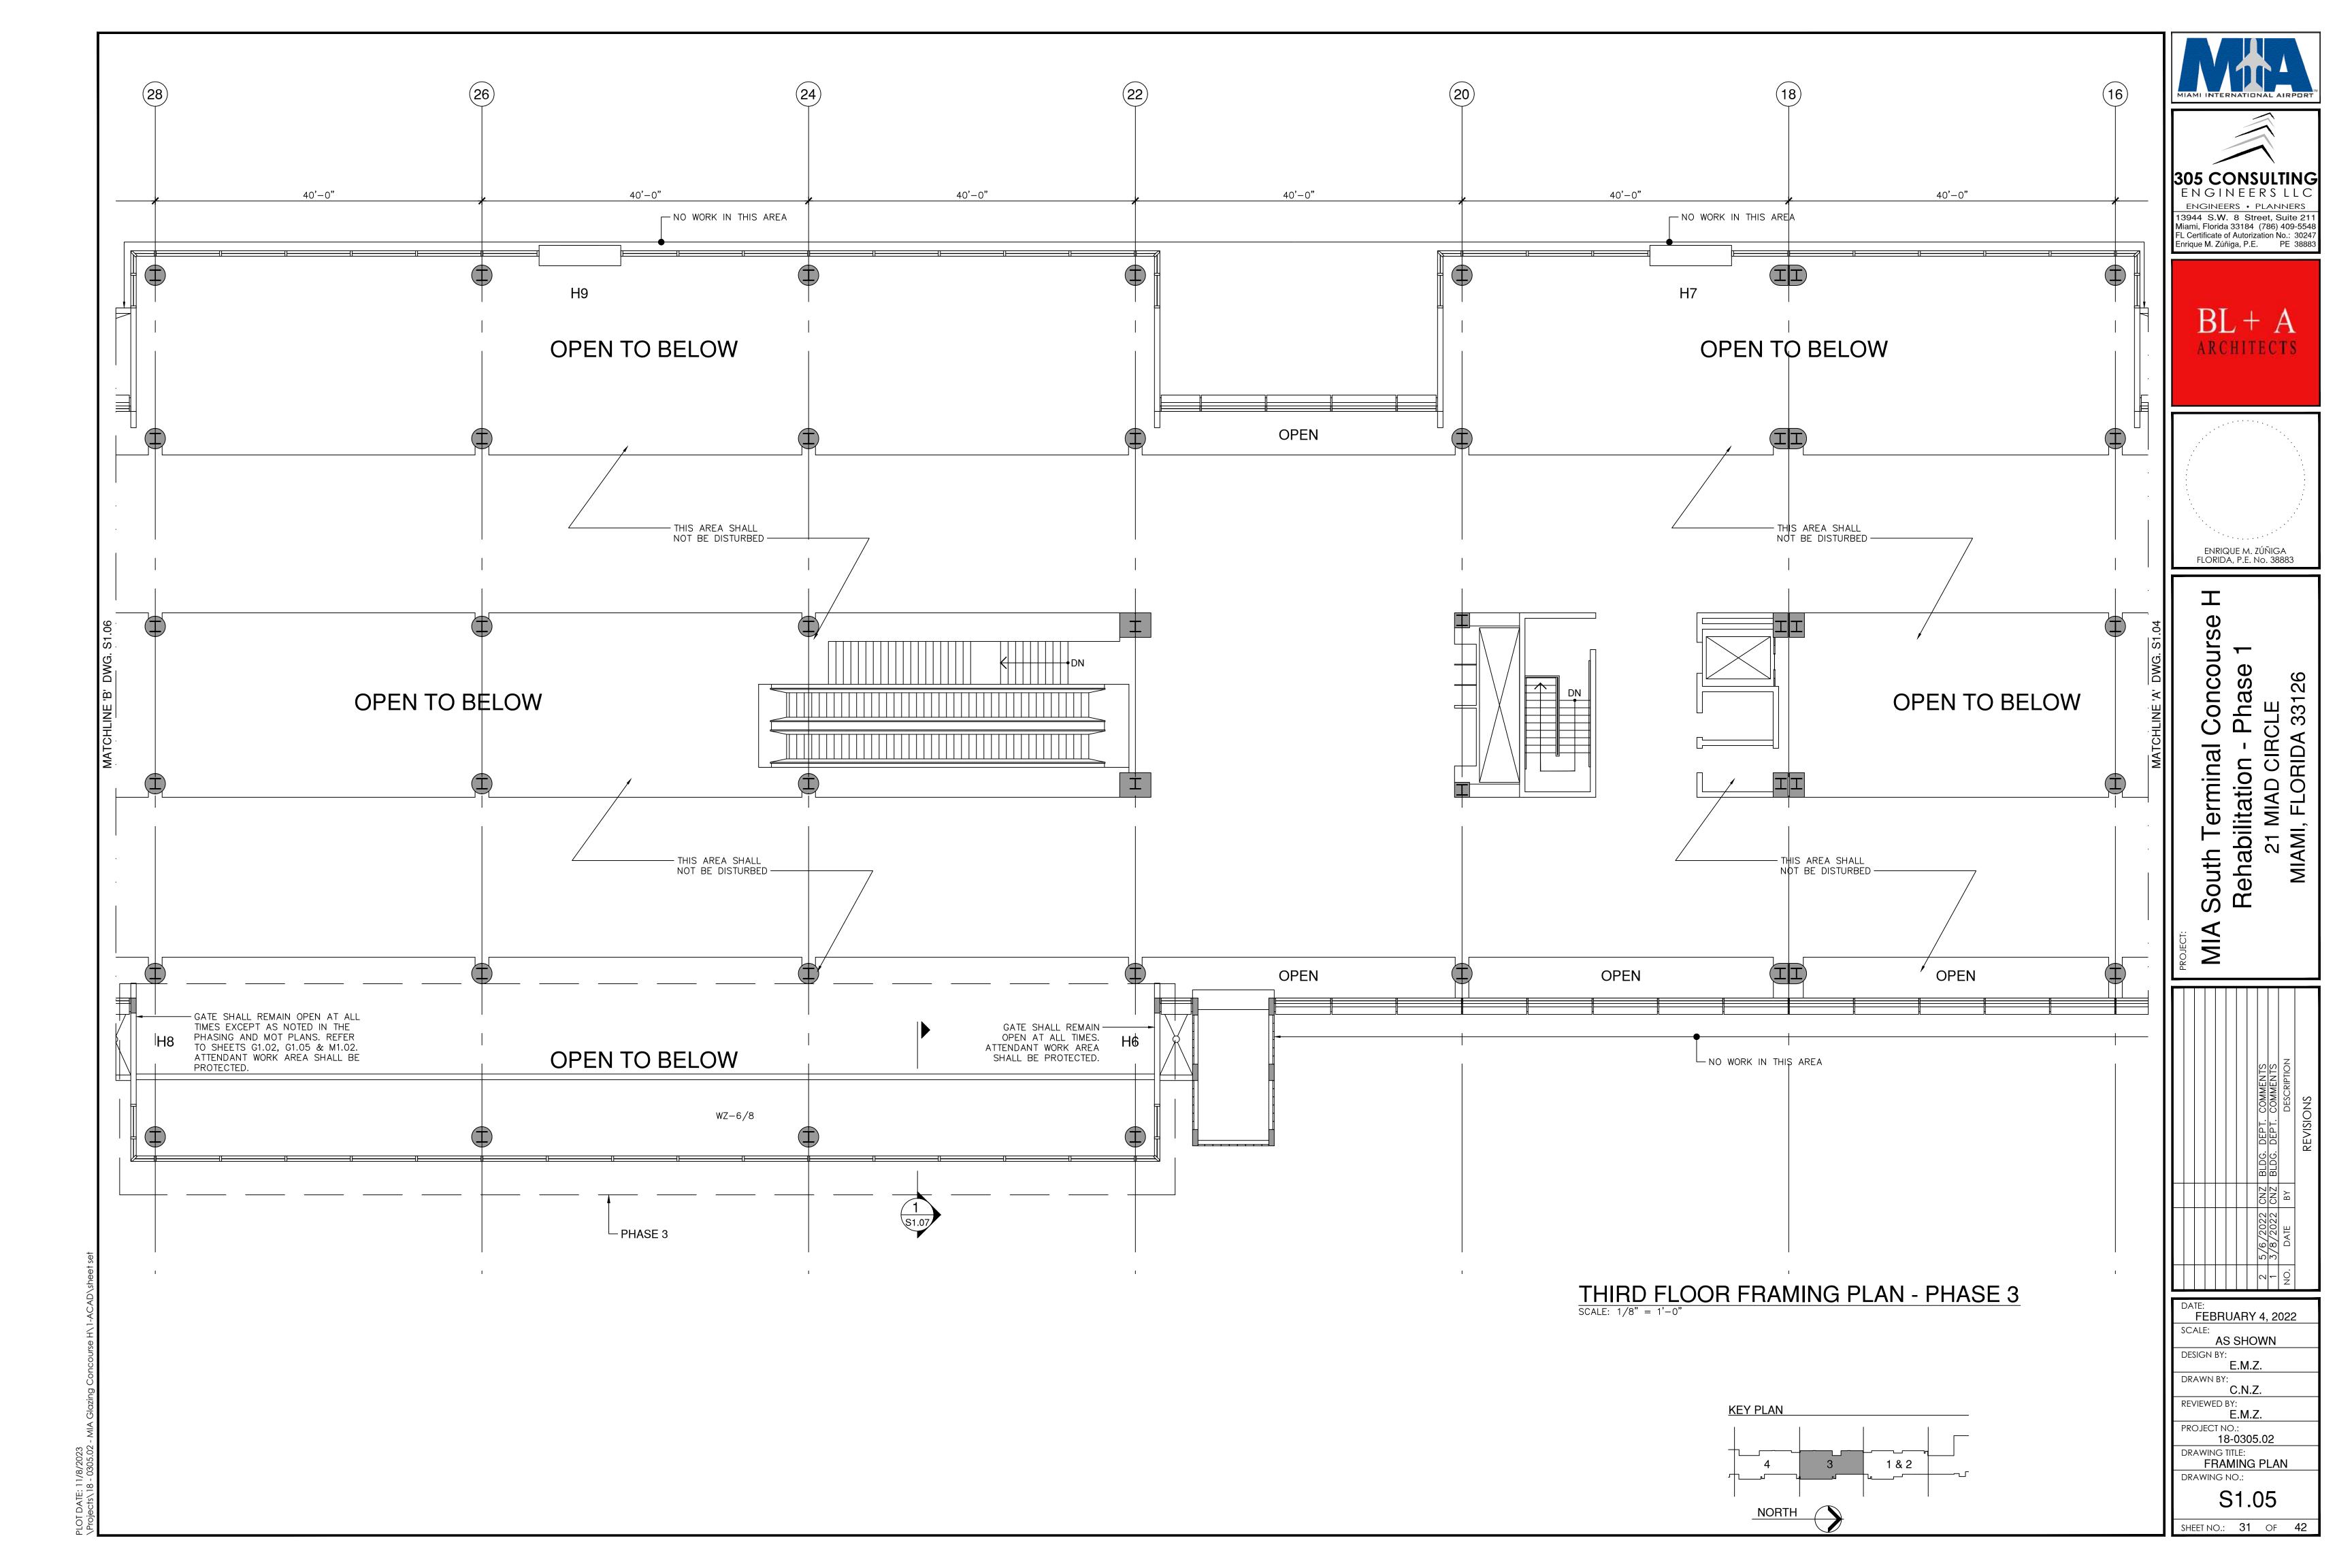








ENGINEERS LLC






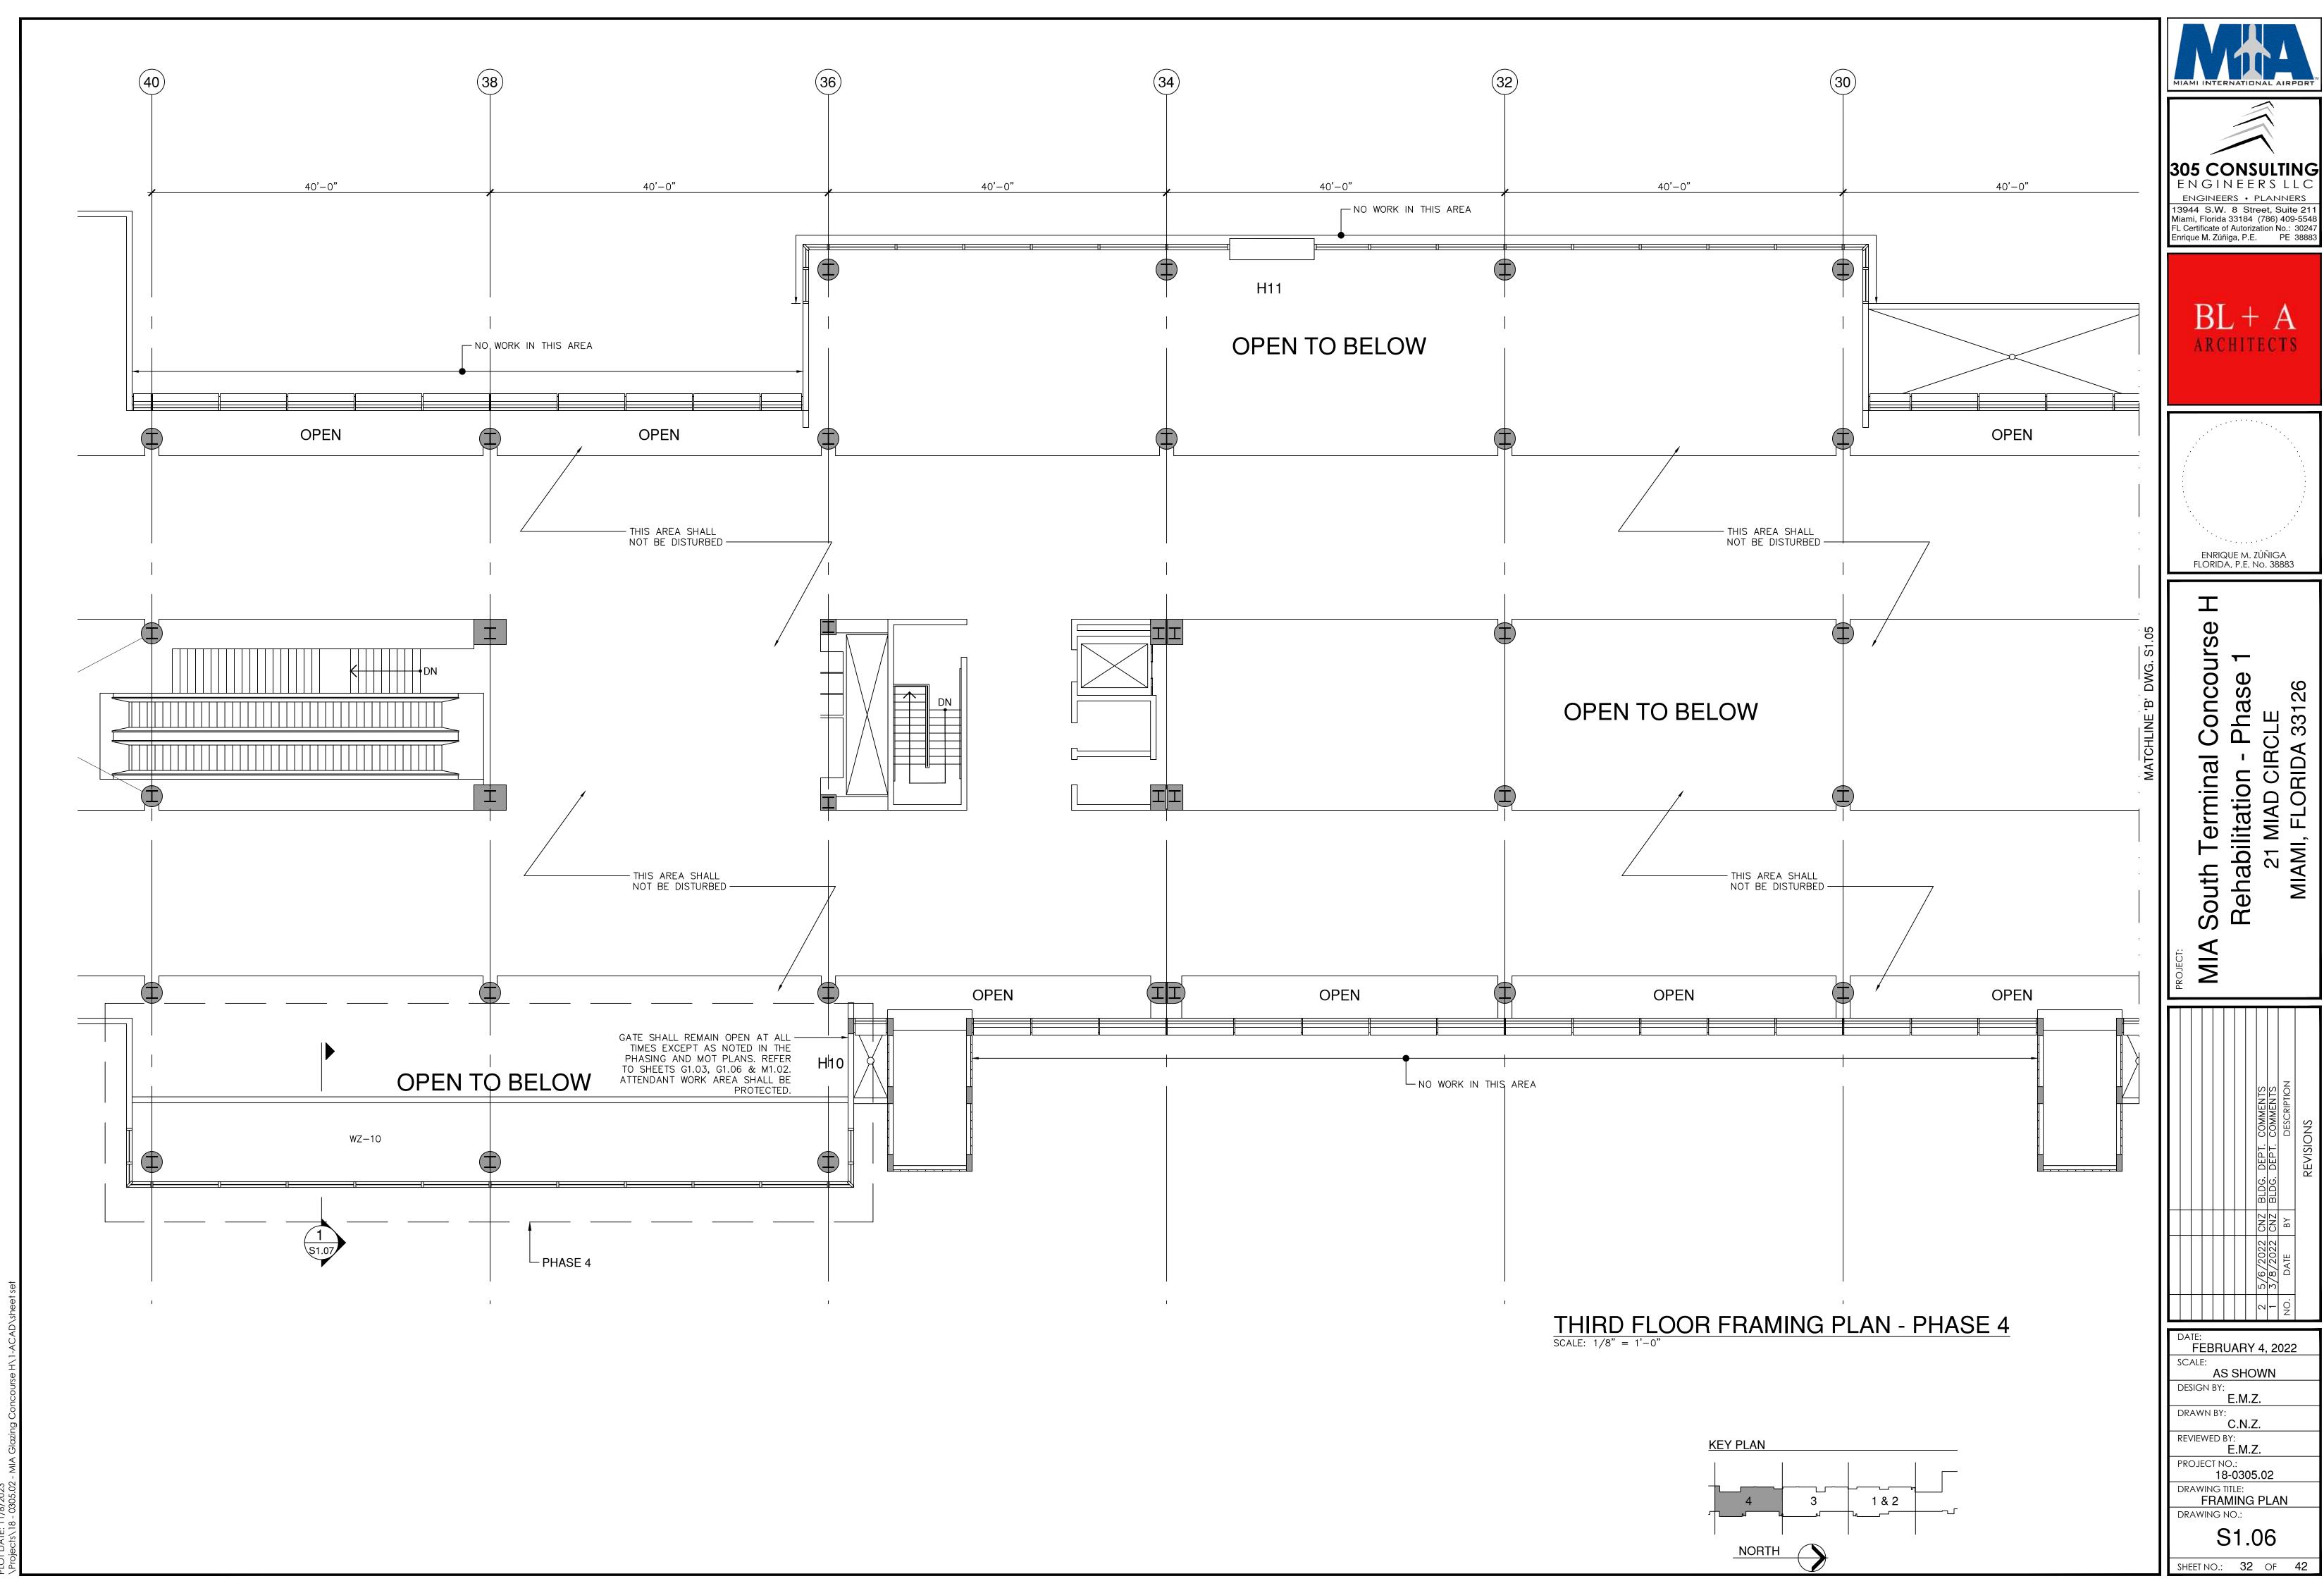

NOTE:
ALL SHIMS SHALL BE HIGH-IMPACT,
NONMETALLIC, NON-COMPRESSIBLE
SUCH AS CRL SHIMSTACK SHIMS AS
MANUFACTURED BY C.R. LAURENCE
CO. OR APPROVED EQUAL

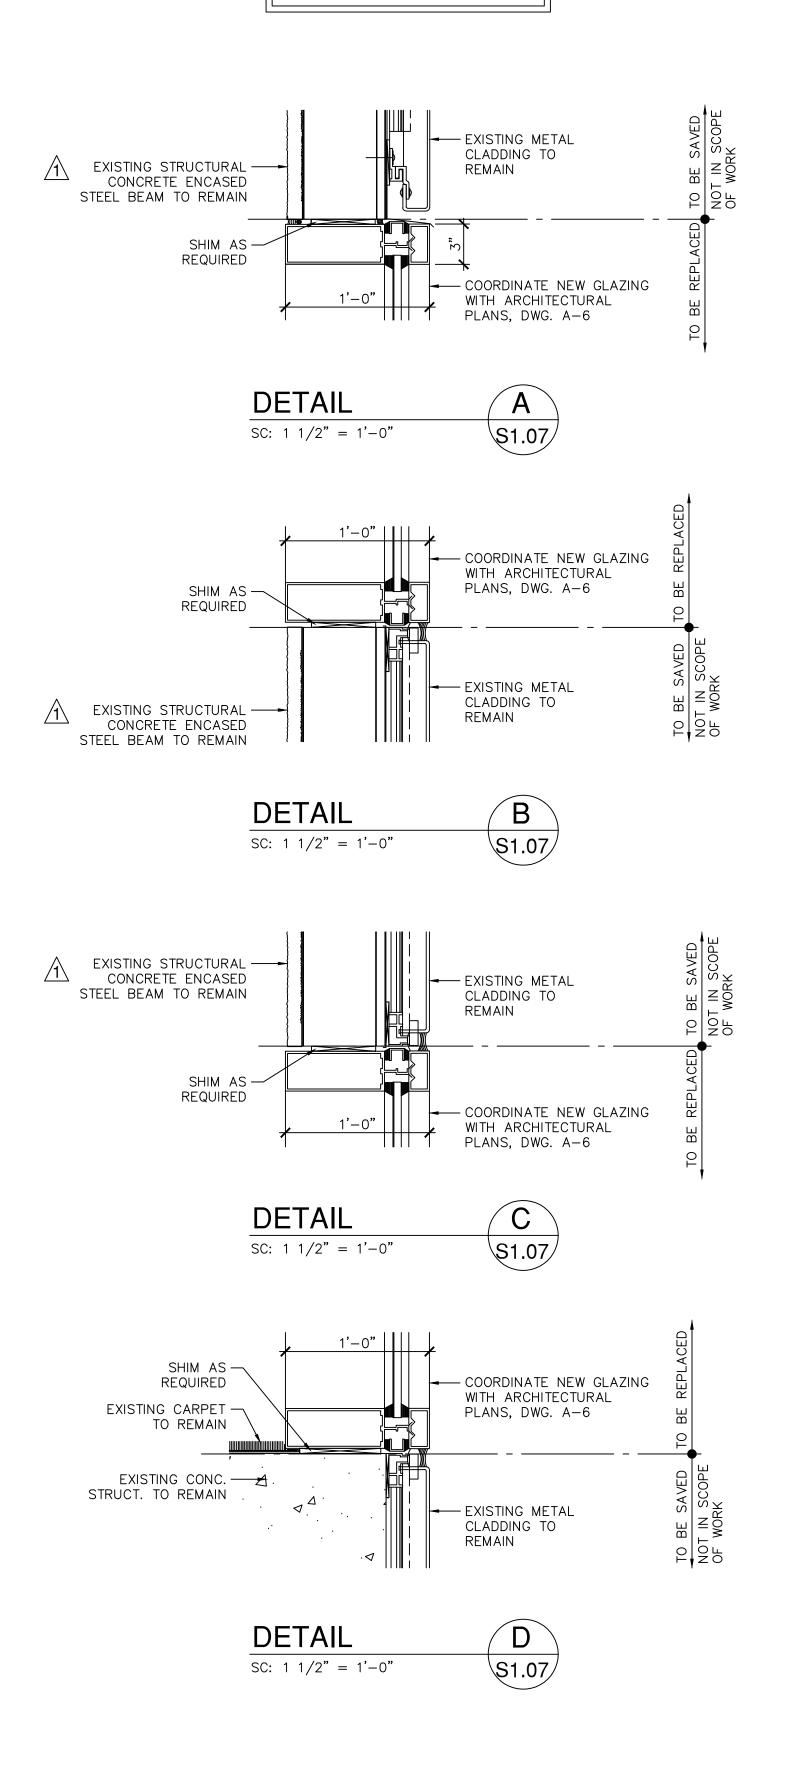


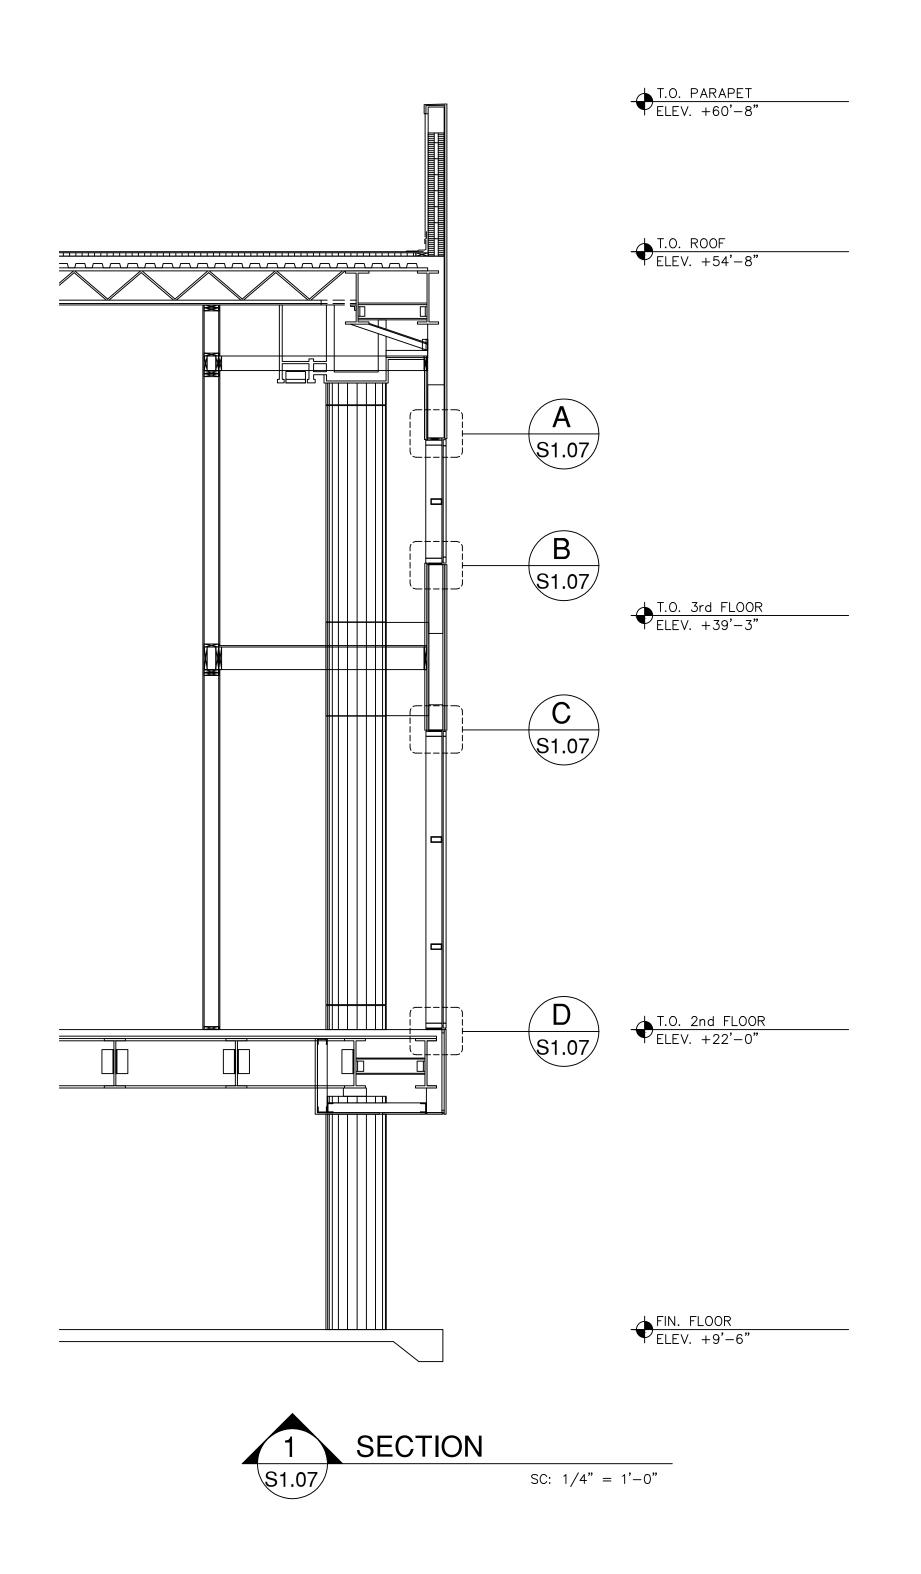





BL + A
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A South Terminal Concourse H Rehabilitation - Phase 1 21 MIAD CIRCLE MIAMI, FLORIDA 33126

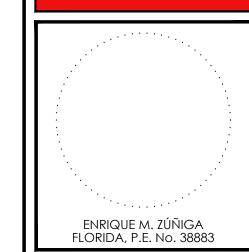PROJECT:

2 5/6/2022 CNZ BLDG. DEPT. COMMENTS

1 3/88/2022 CNZ BRDGCDEPP: COMMENTS

NO. DATE BY DESCRIPTION

REVISIONS

DATE:
FEBRUARY 4, 2022
SCALE:
AS SHOWN

DESIGN BY:
E.M.Z.

DRAWN BY:
C.N.Z.

REVIEWED BY:
E.M.Z.


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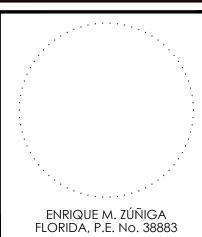
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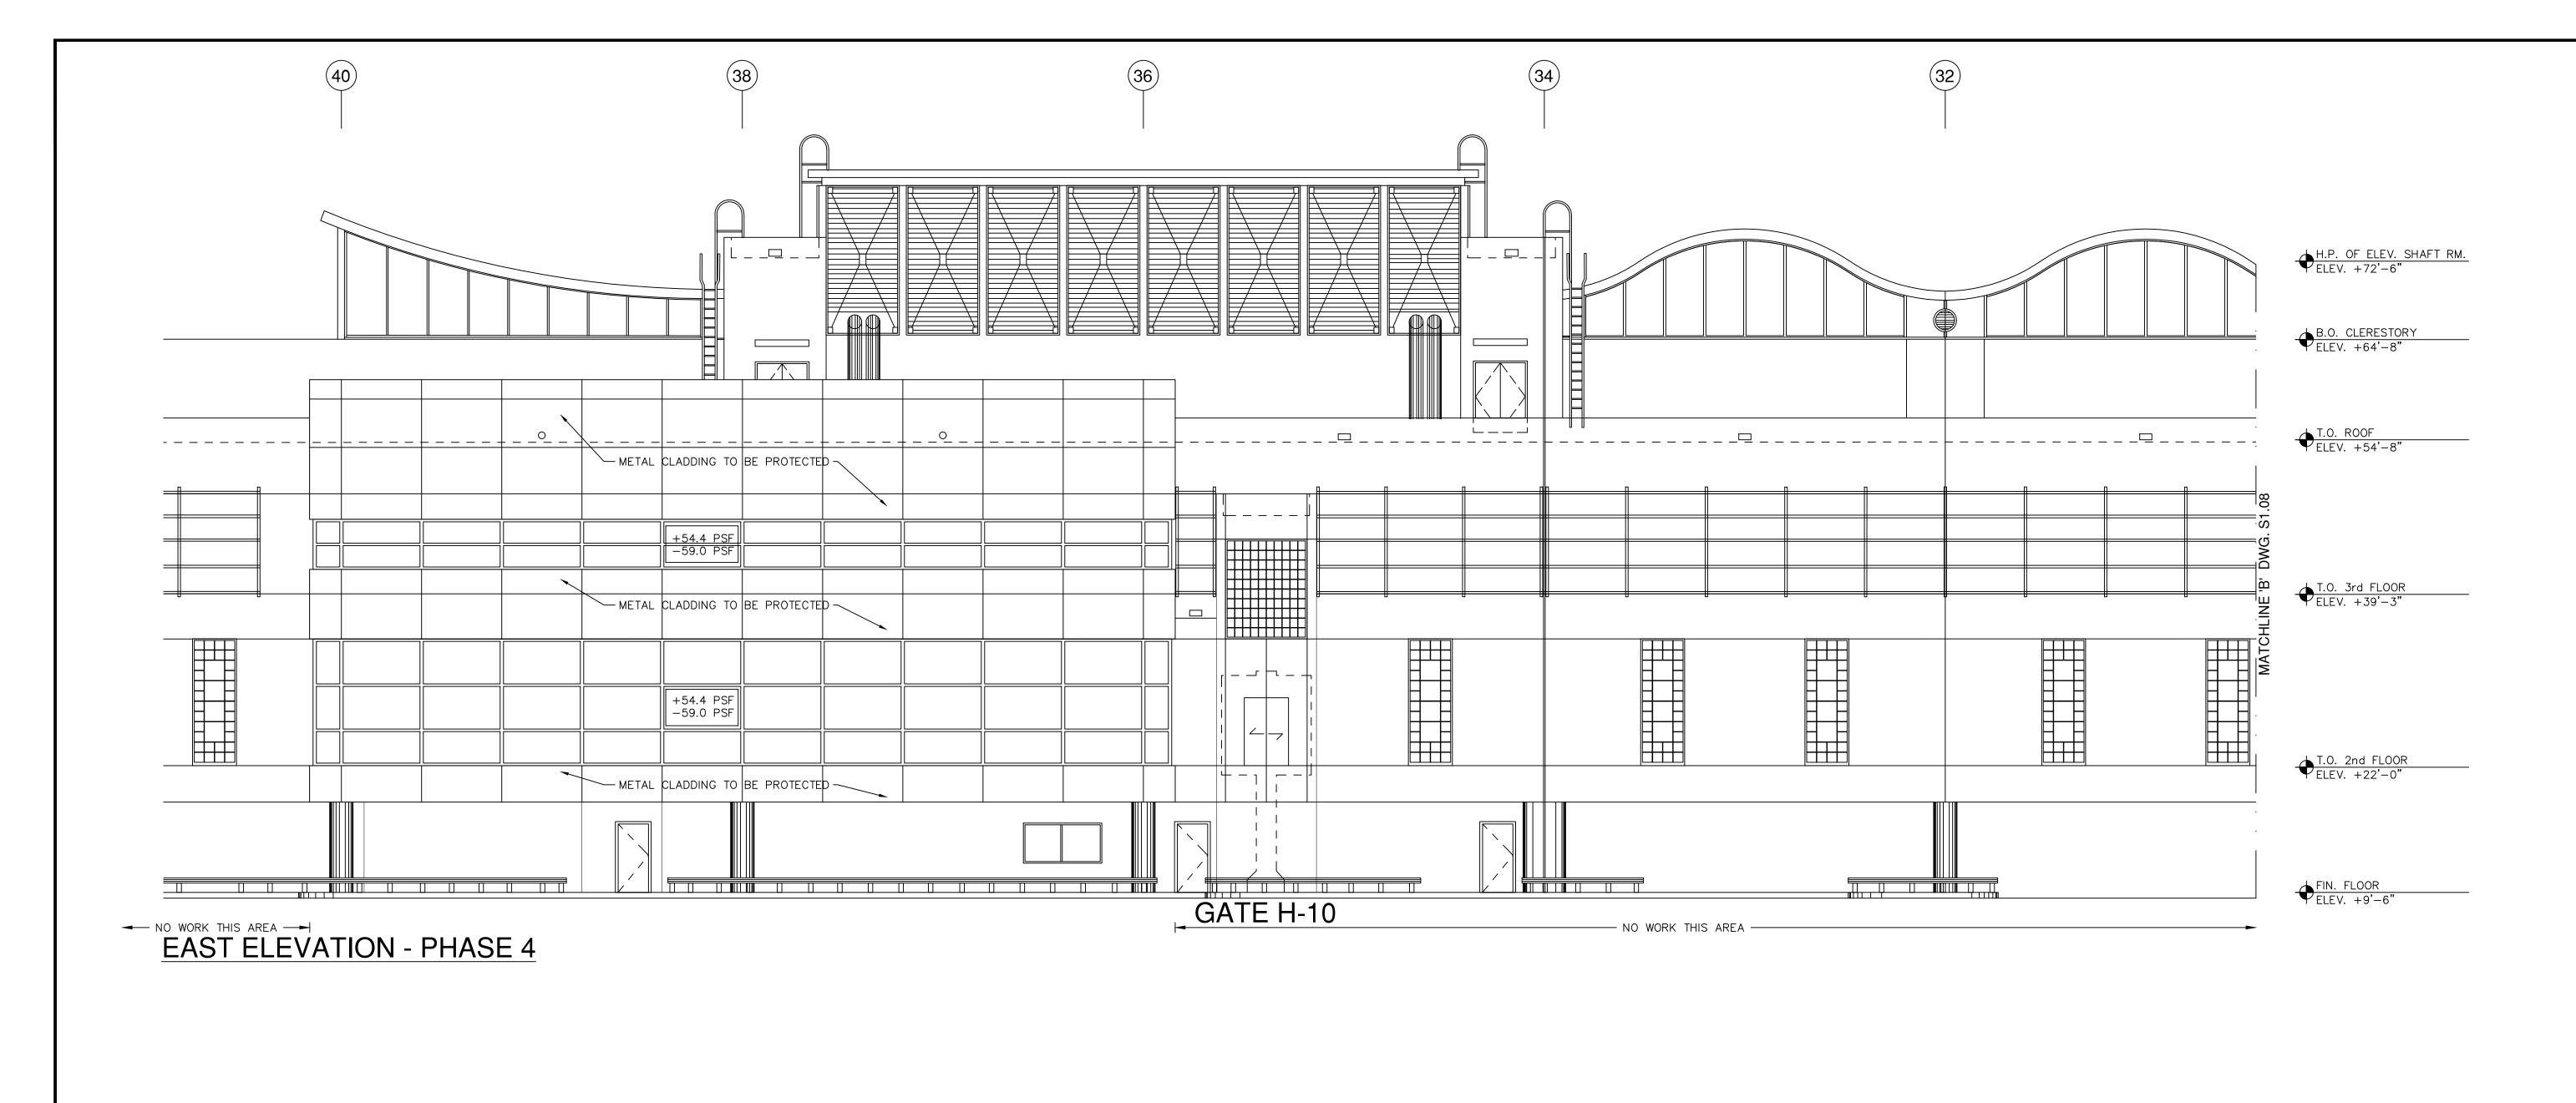


ARCHITECTS



5/6/2022 CNZ BLDG. DEPT. COMMENTS 3/8/2022 CNZ BLDG. DEPT. COMMENTS DATE BY

EAST ELEVATION

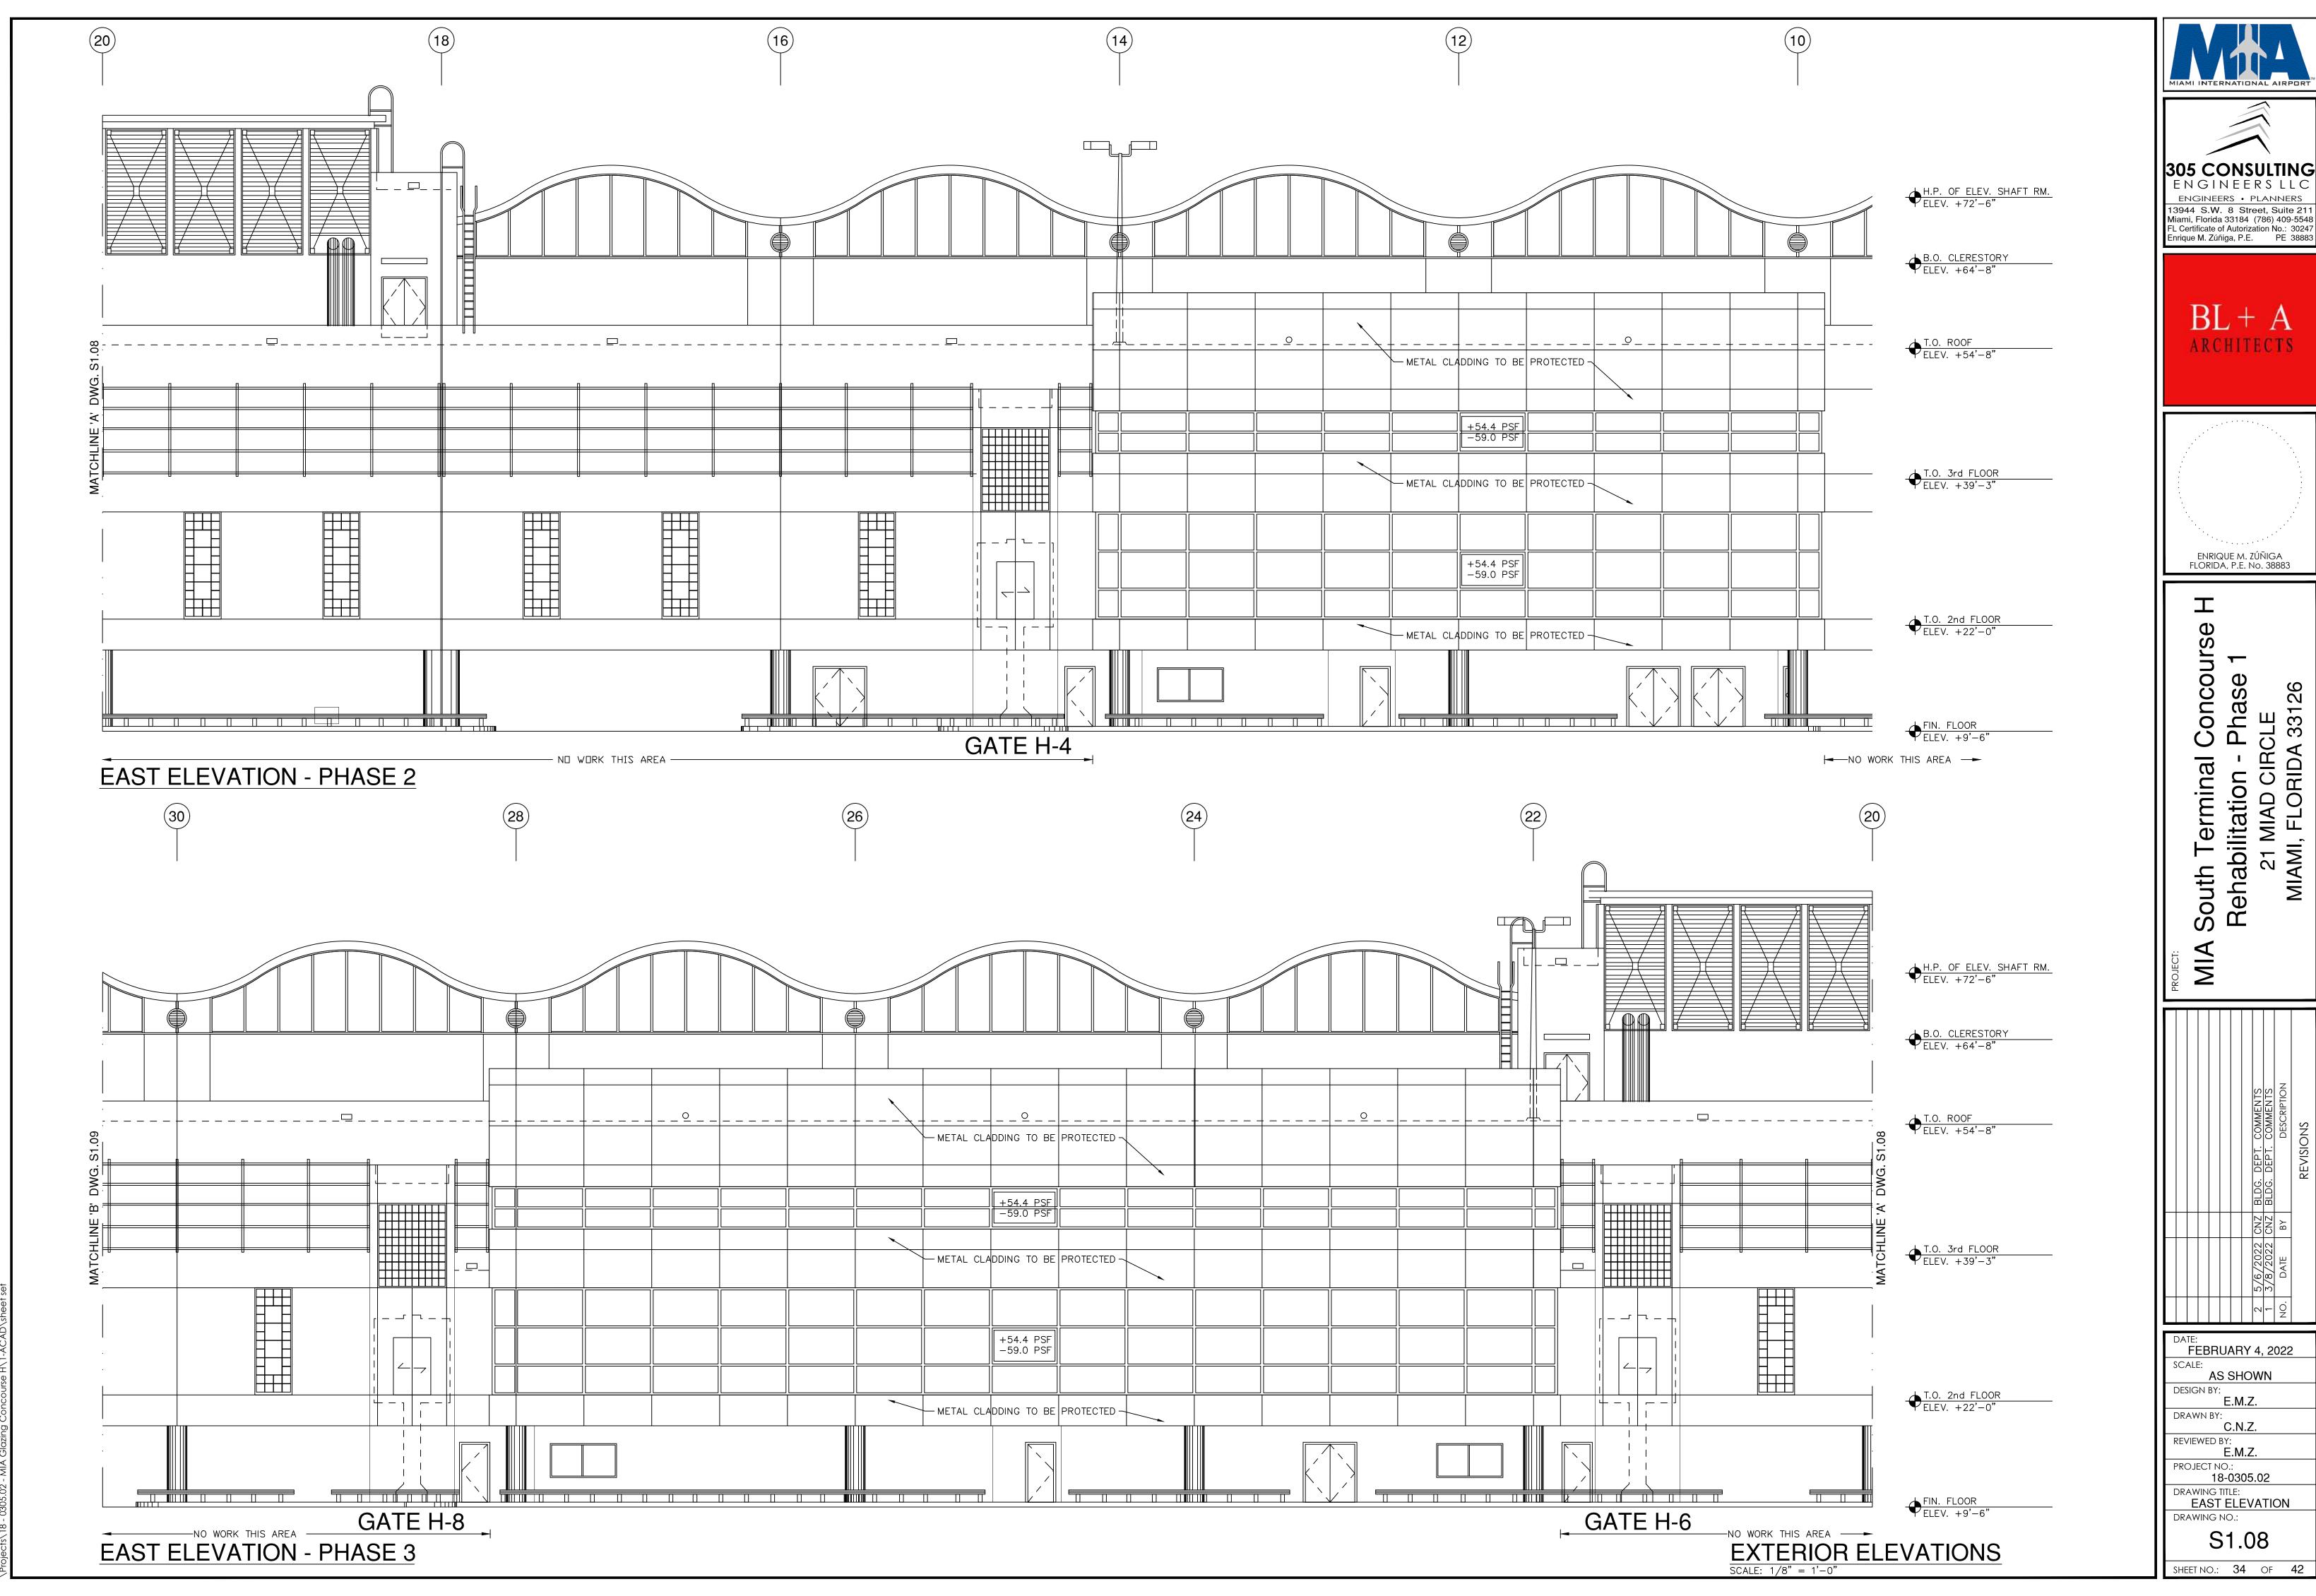

MIAMI INTERNATIONAL AIRPORT



BL + A



ENRIQUE M. ZÚÑIGA FLORIDA, P.E. No. 38883

MIA South Terminal Concourse F Rehabilitation - Phase 1 21 MIAD CIRCLE MIAMI, FLORIDA 33126

2 5/6/2022 CNZ BLDG. DEPT. COMMENTS
1 3/8/2022 CNZ BLDG. DEPT. COMMENTS
NO. DATE BY DESCRIPTION
REVISIONS

DATE:
FEBRUARY 4, 2022

SCALE:
AS SHOWN

DESIGN BY:
E.M.Z.

DRAWN BY:
C.N.Z.

REVIEWED BY:
E.M.Z.

E.M.Z.

PROJECT NO.:


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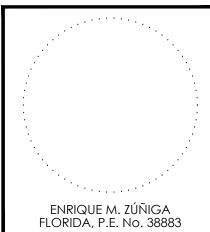
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ARCHITECTS




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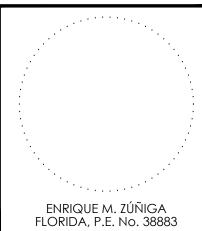
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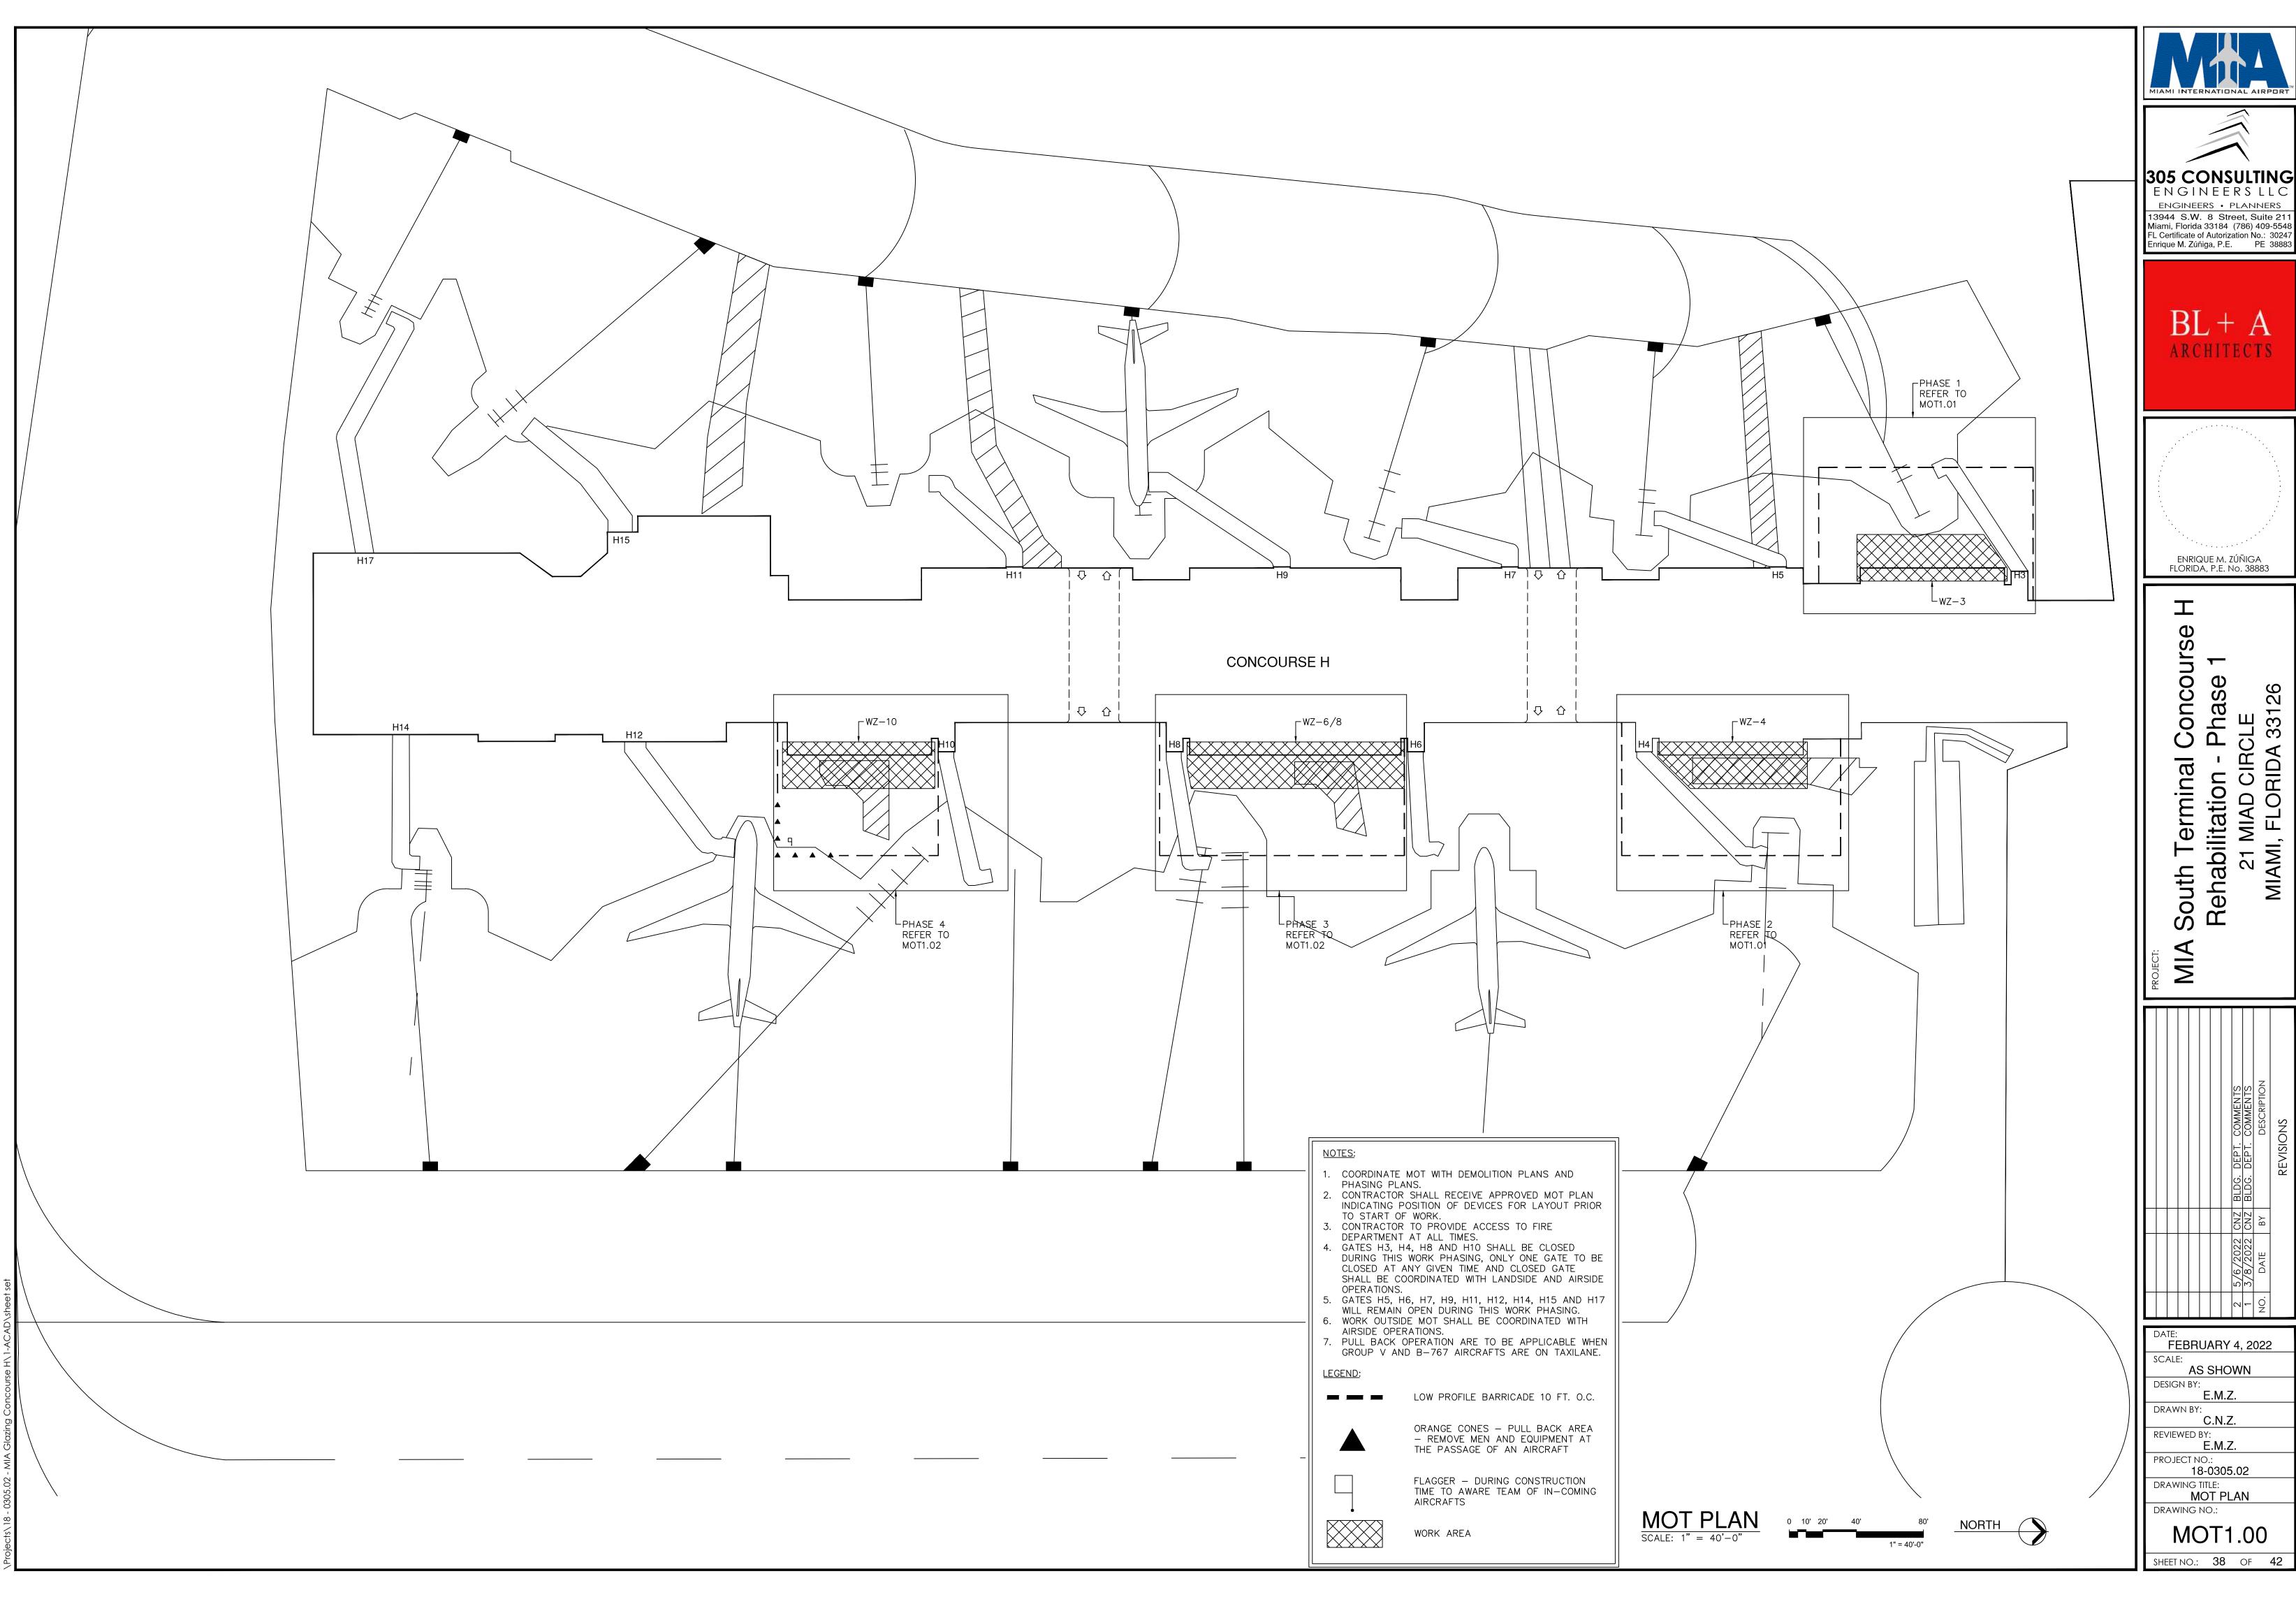
A South Terminal Concourse F Rehabilitation - Phase 1 21 MIAD CIRCLE MIAMI, FLORIDA 33126

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	3/8/2022   CNZ	CNZ	BLDG. DEPT. COMMENTS
Ž	NO. DATE	ВУ	DESCRIPTION
			REVISIONS

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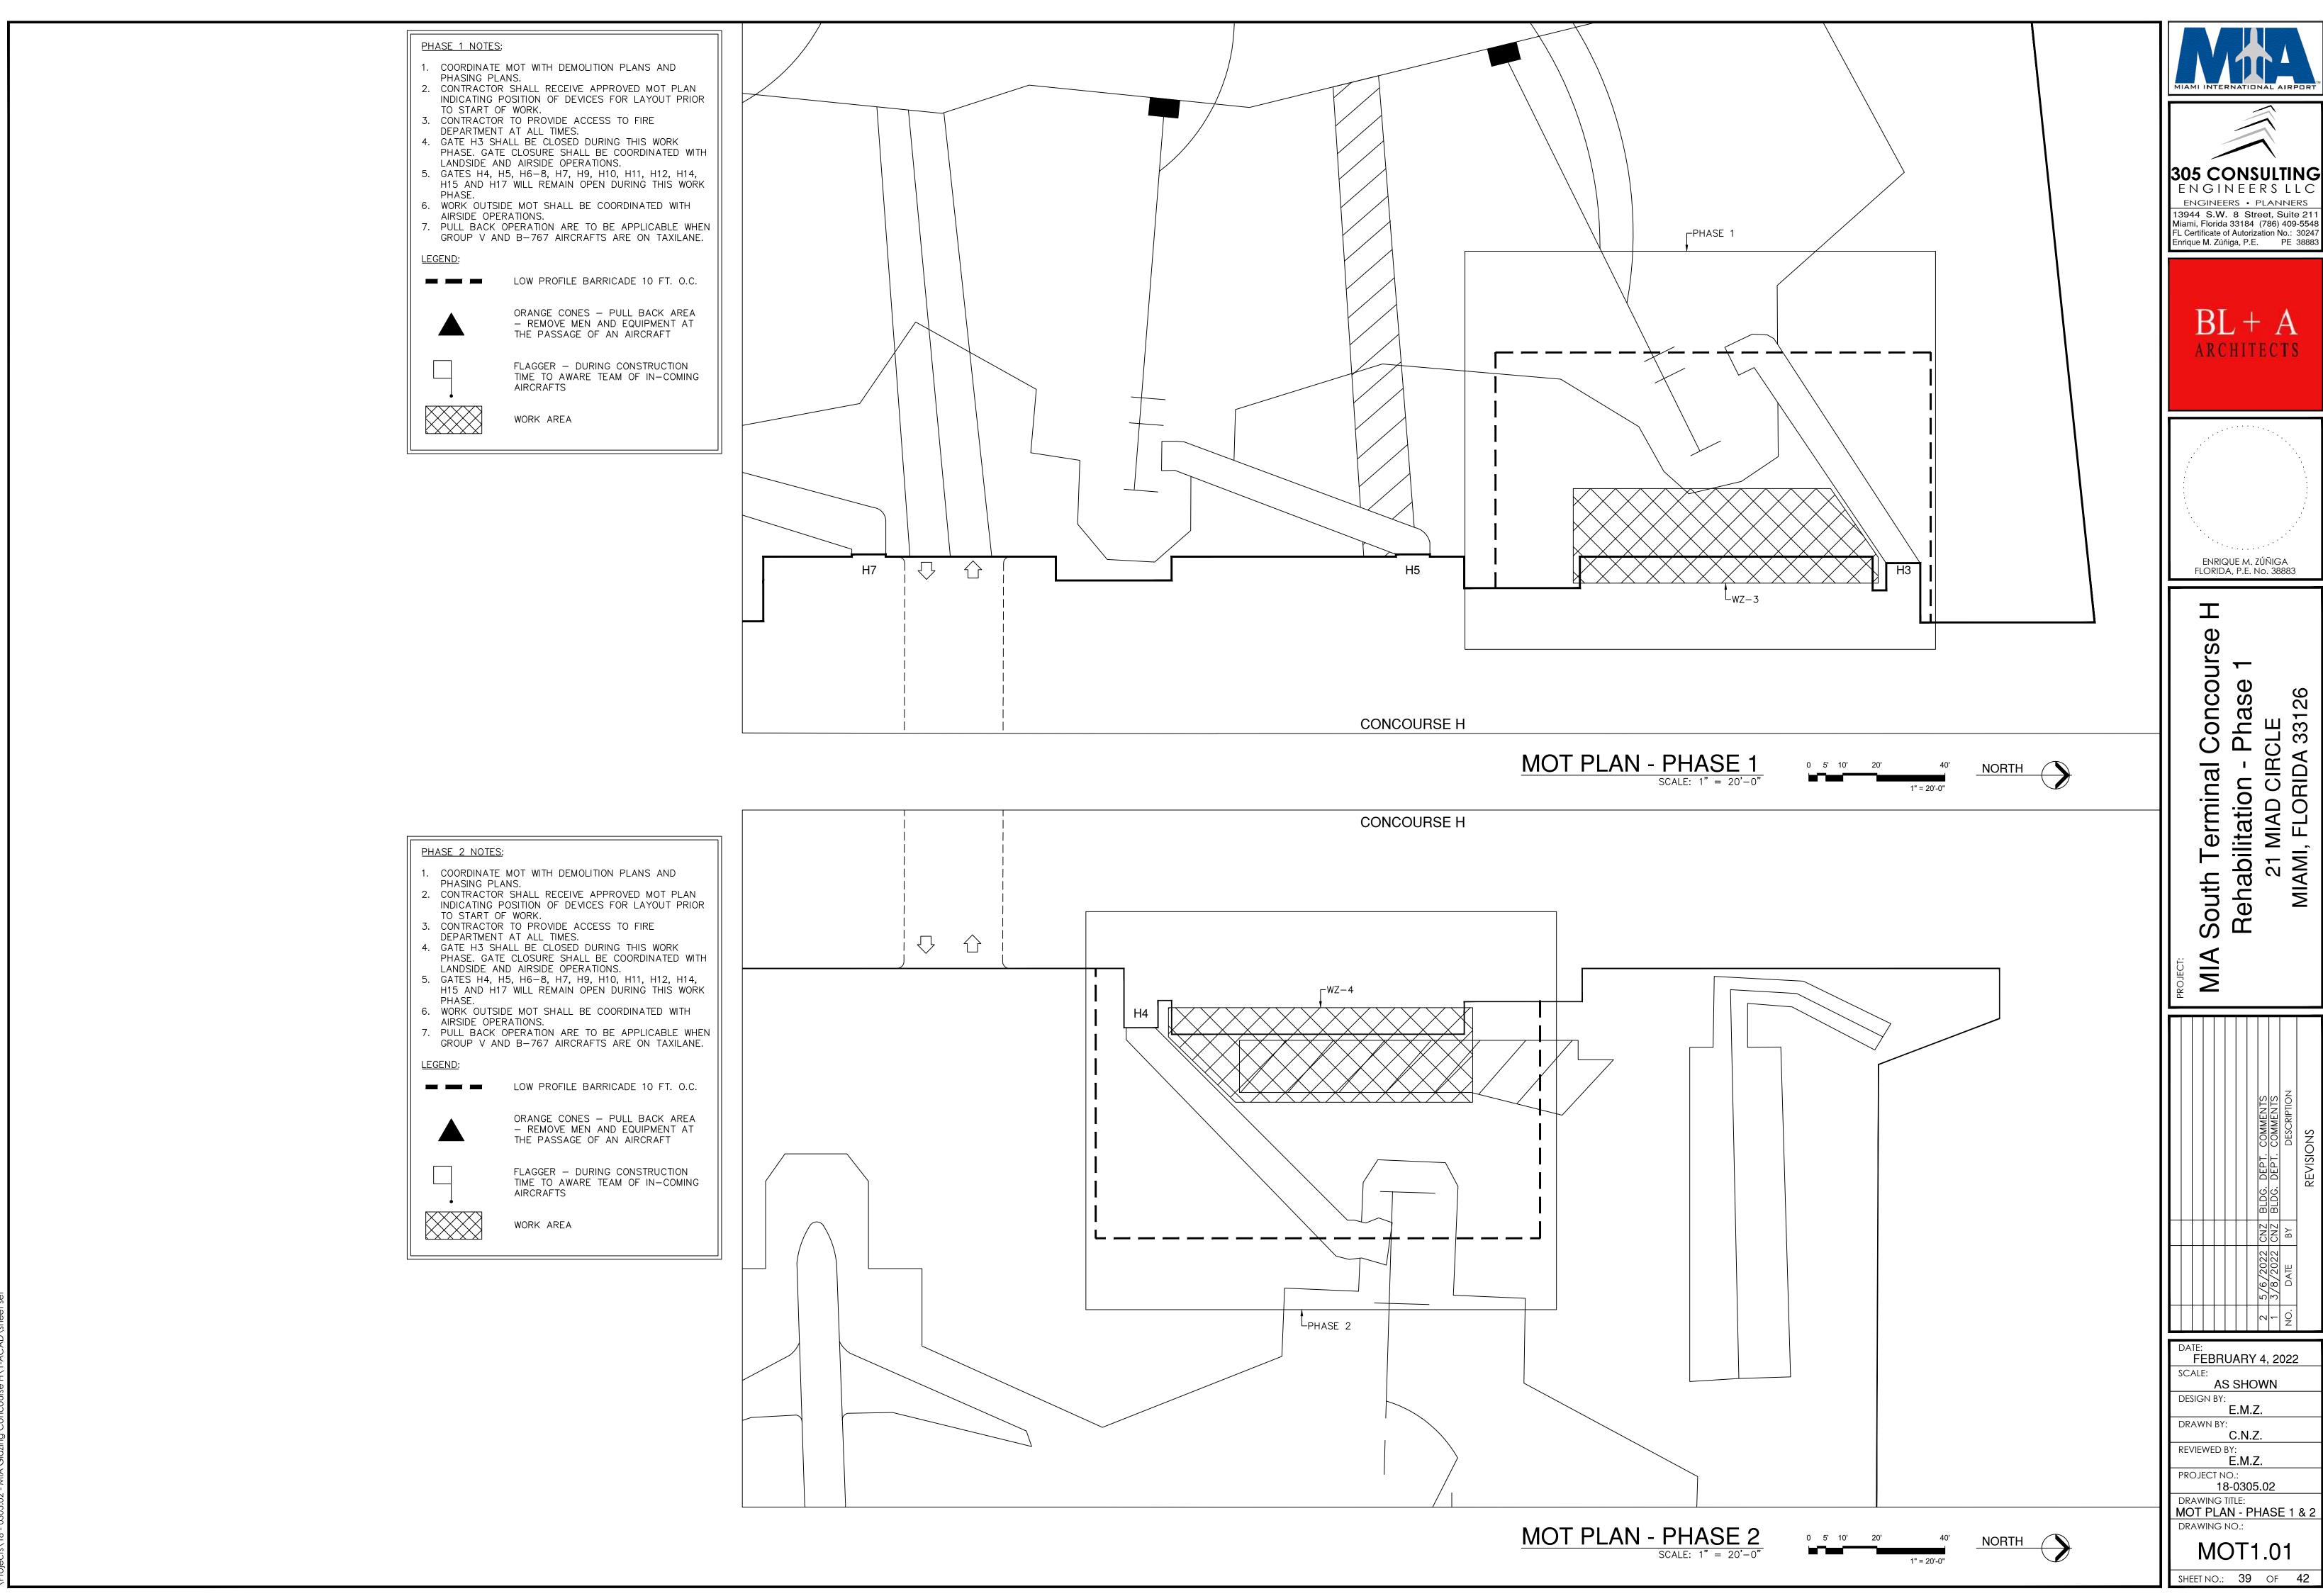
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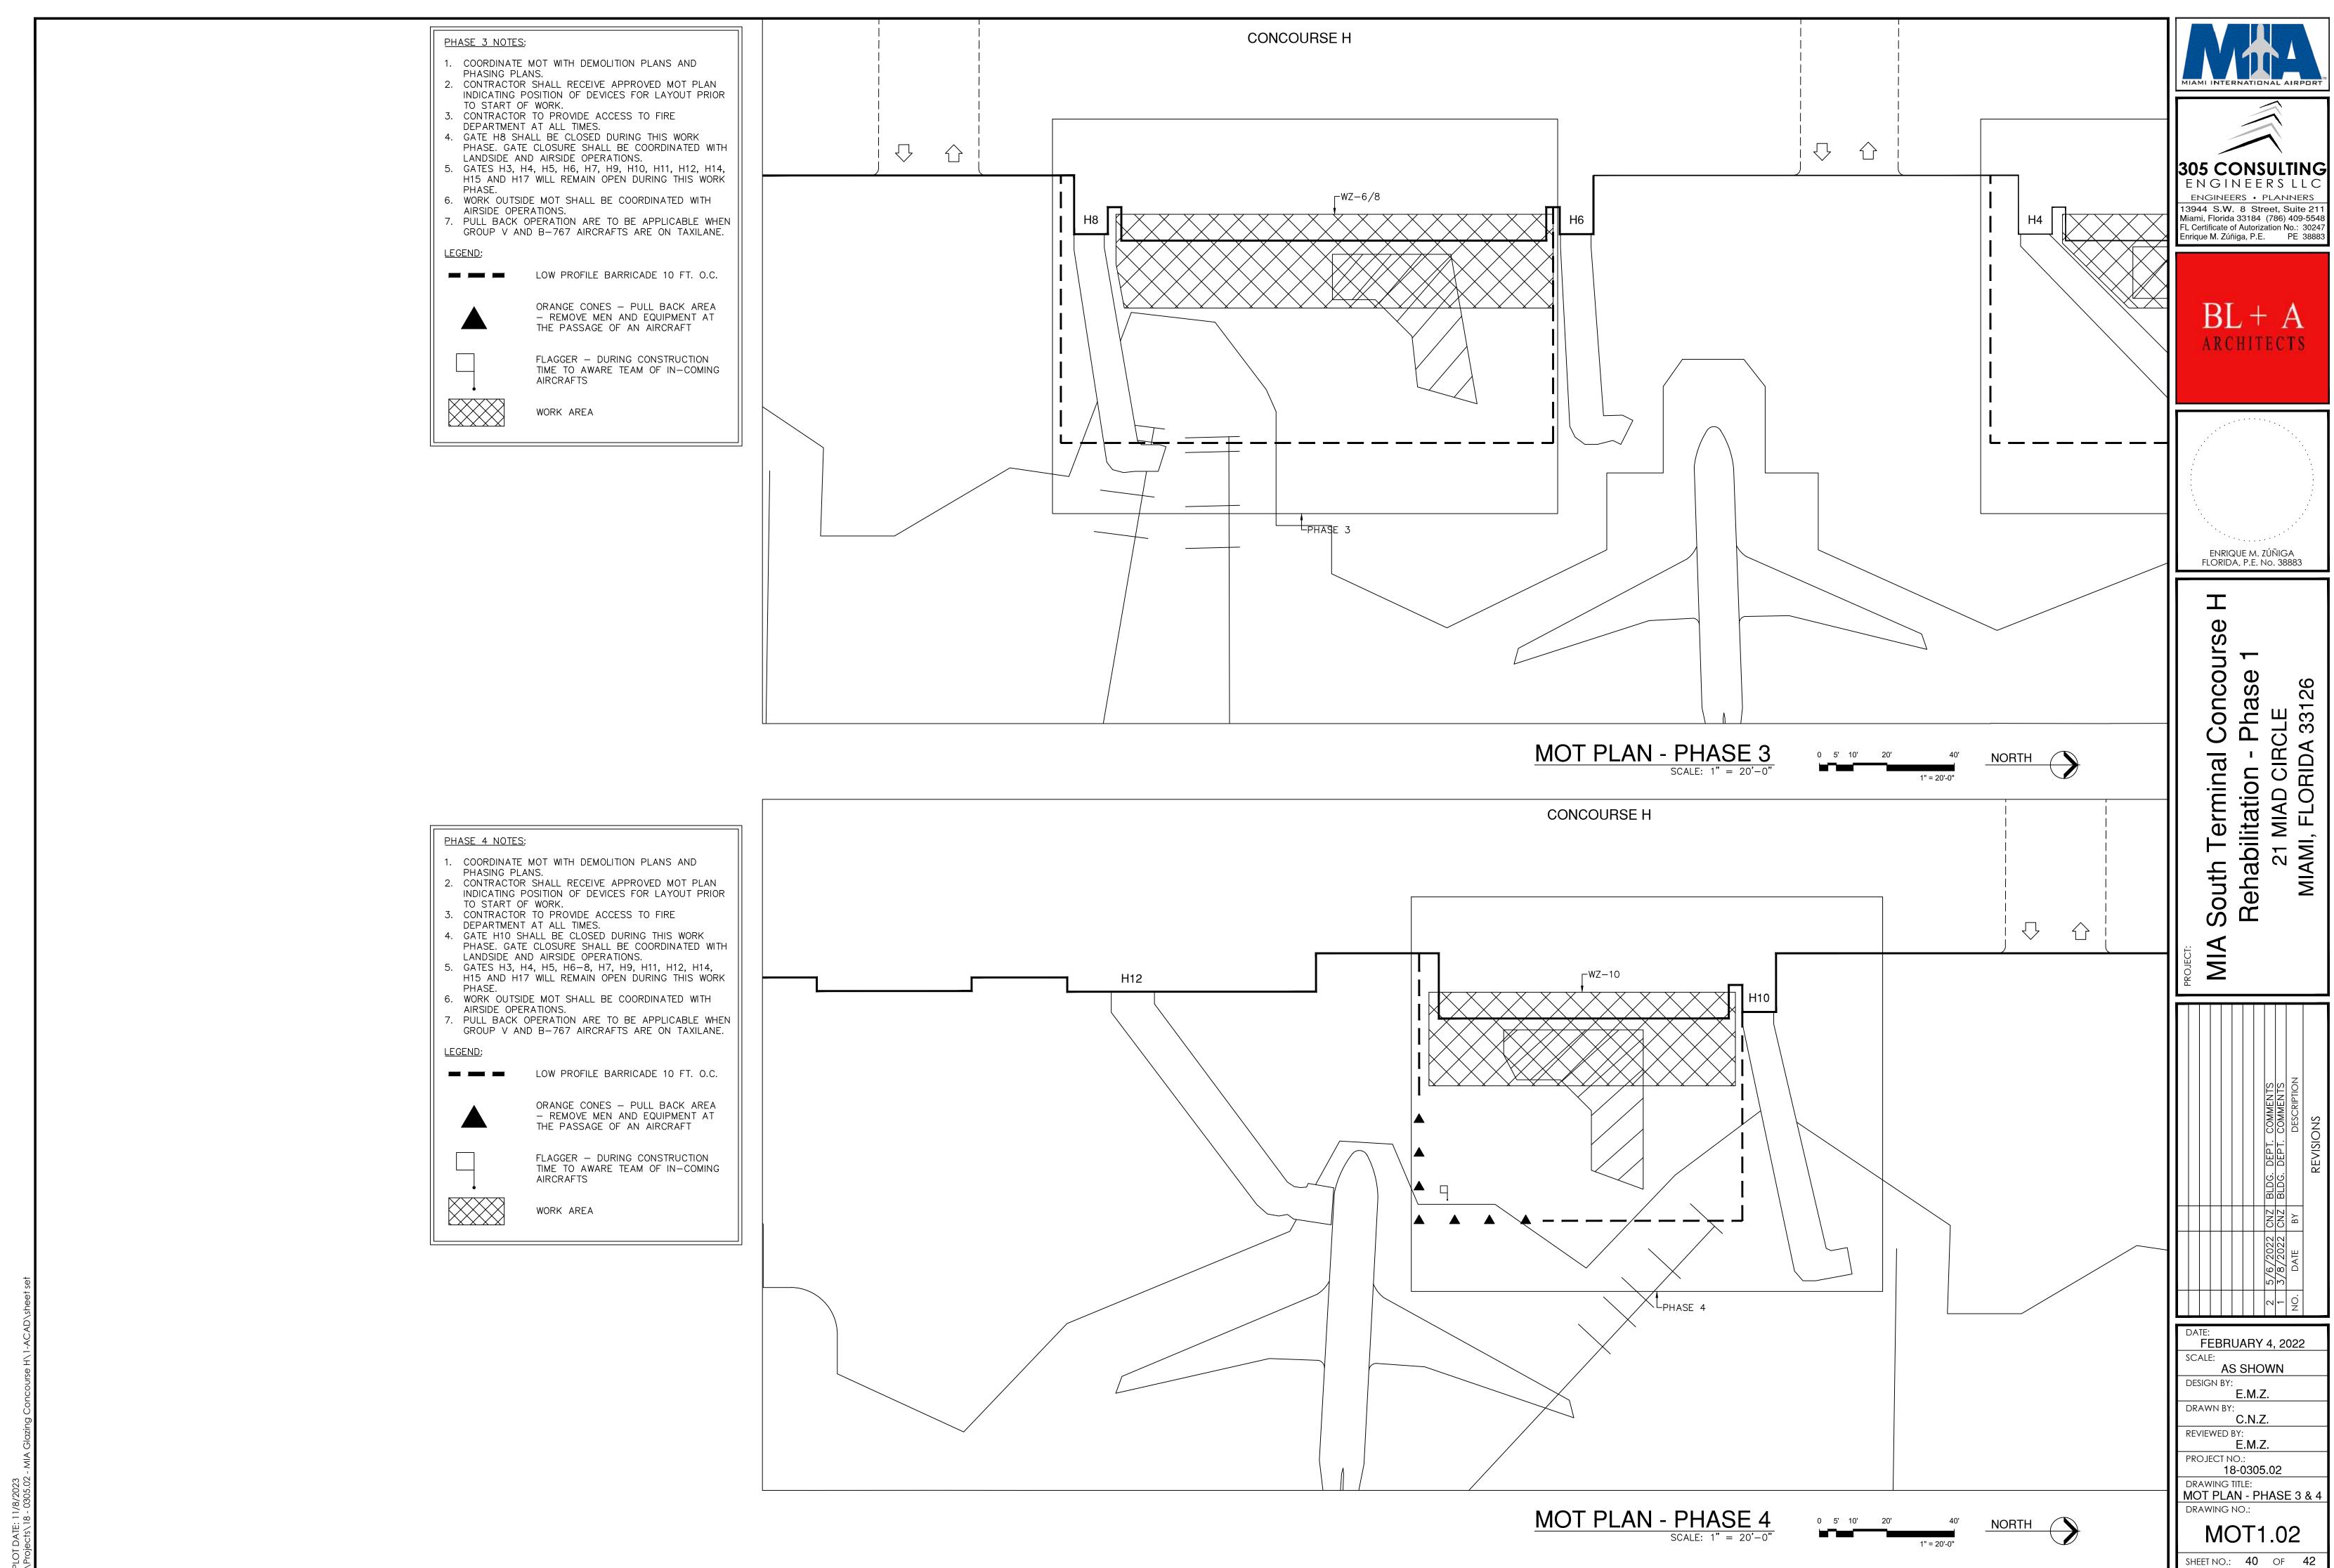


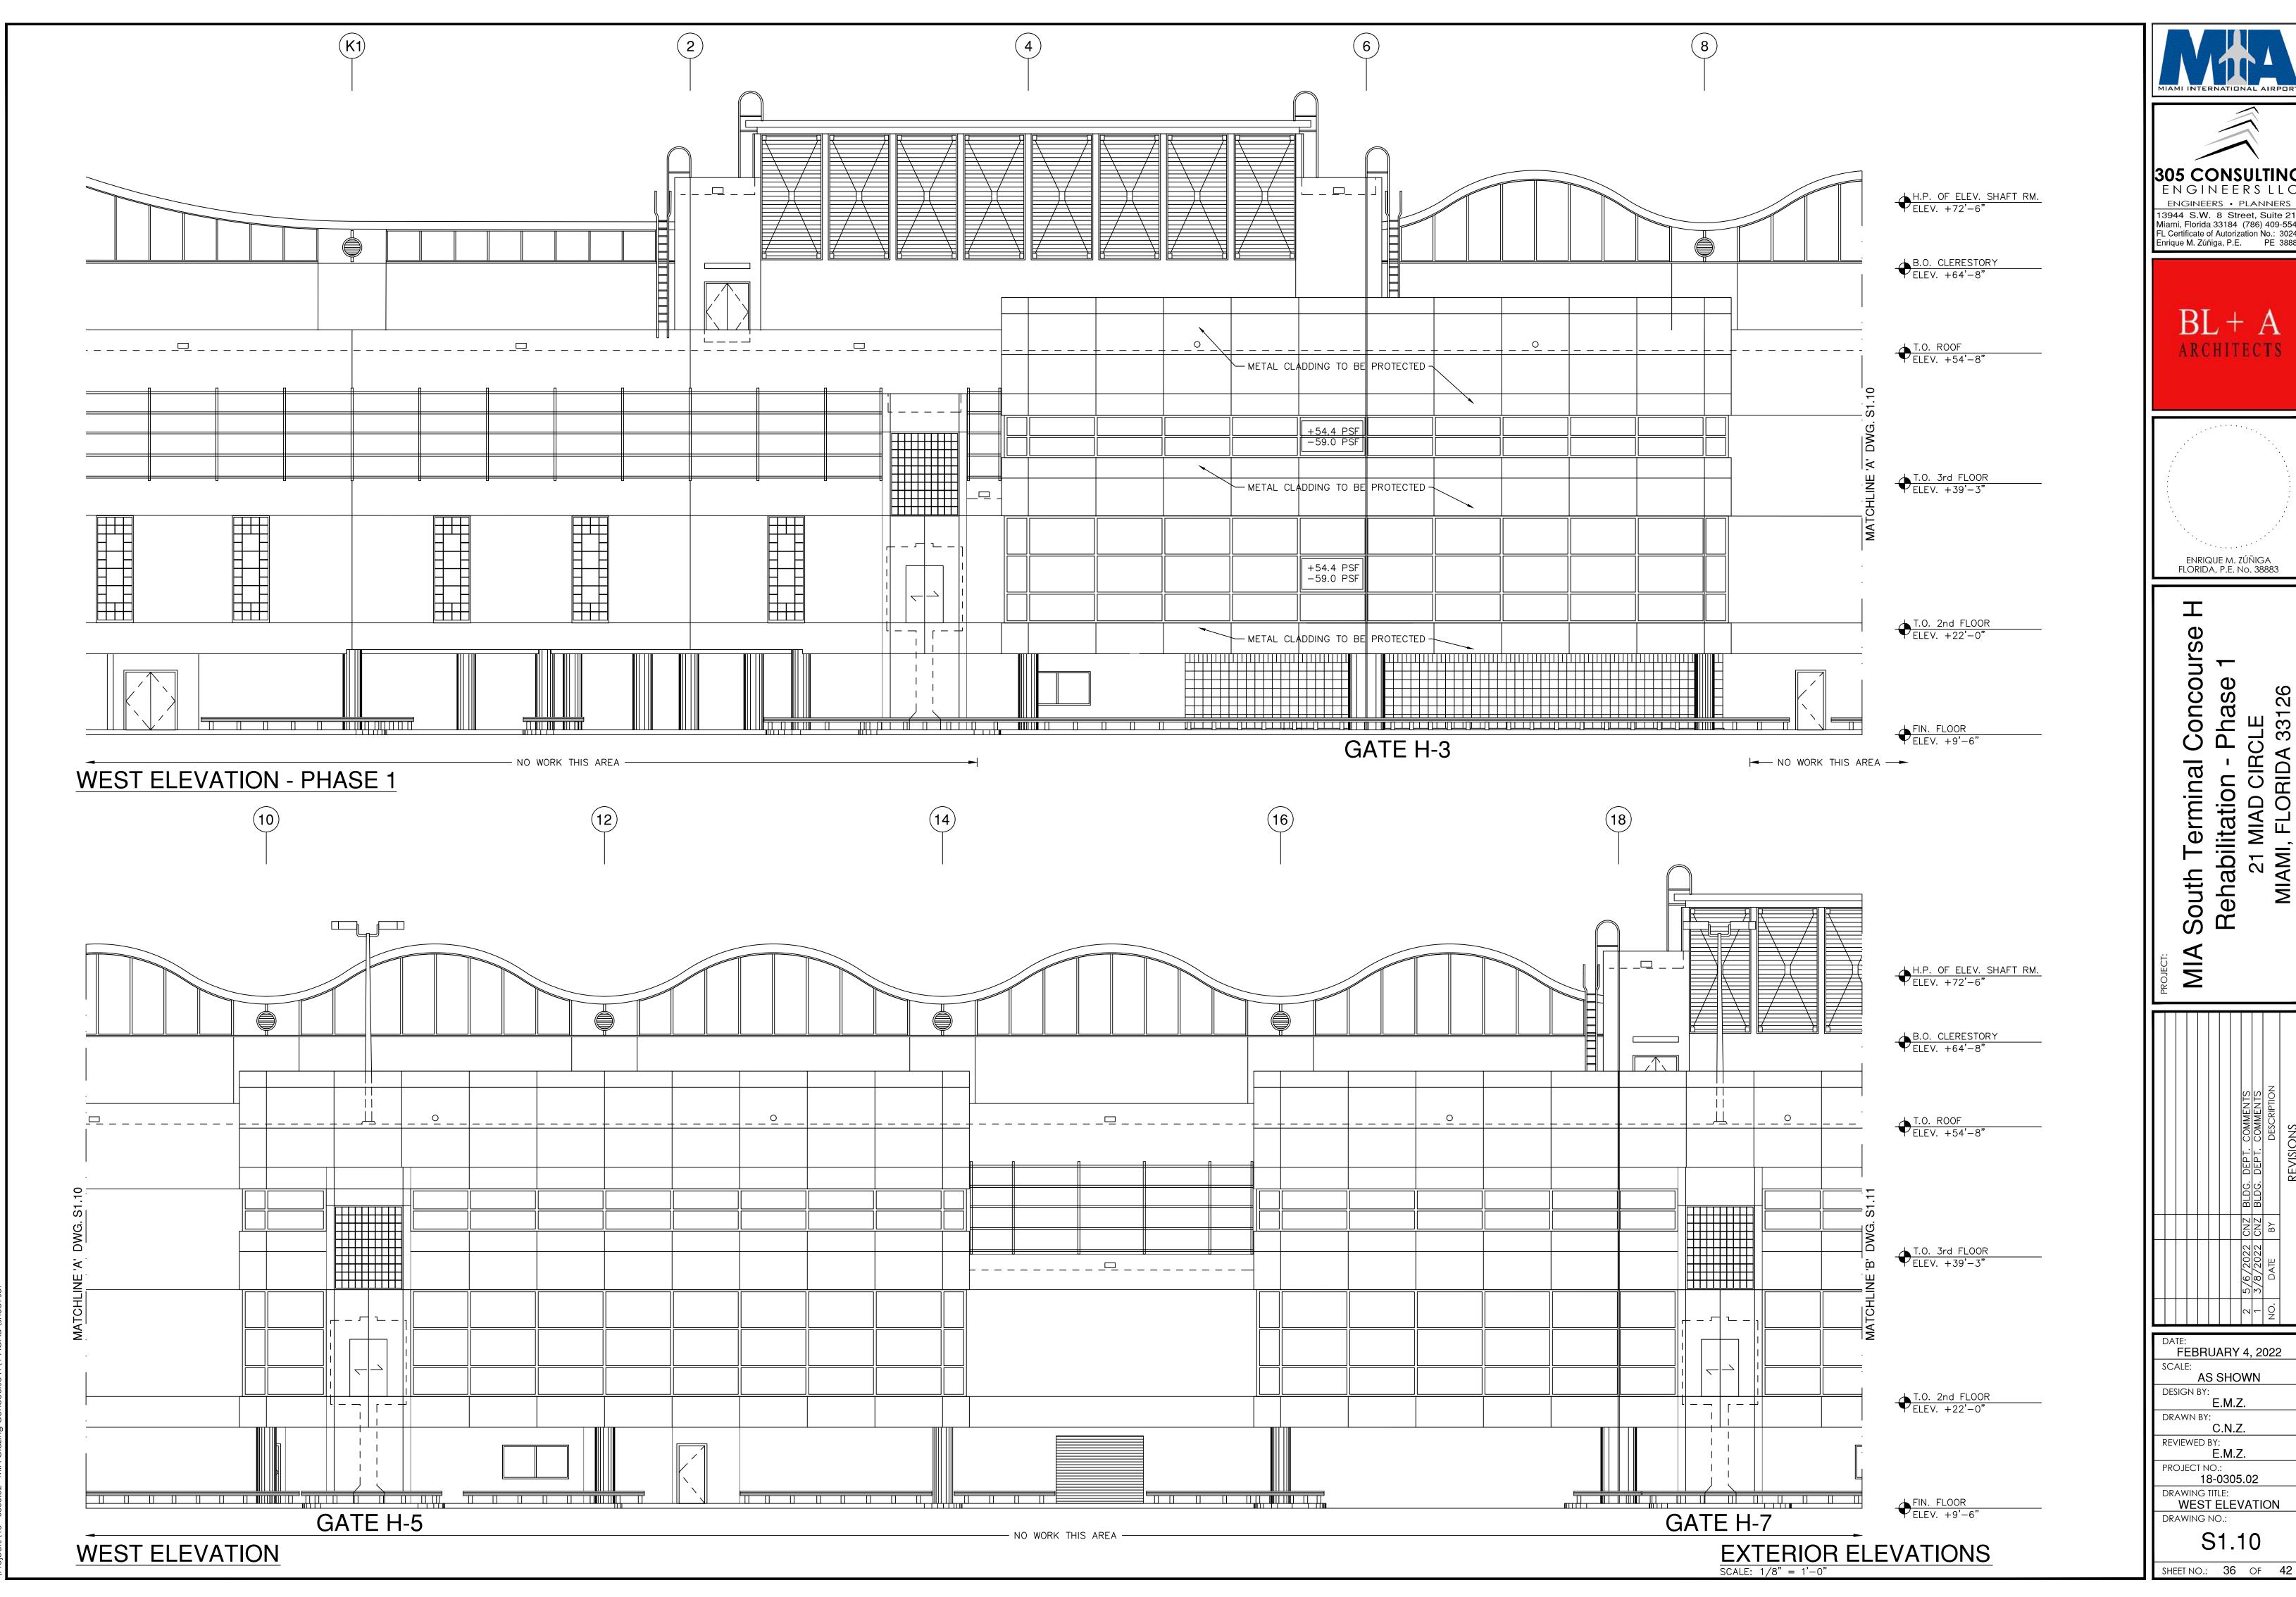

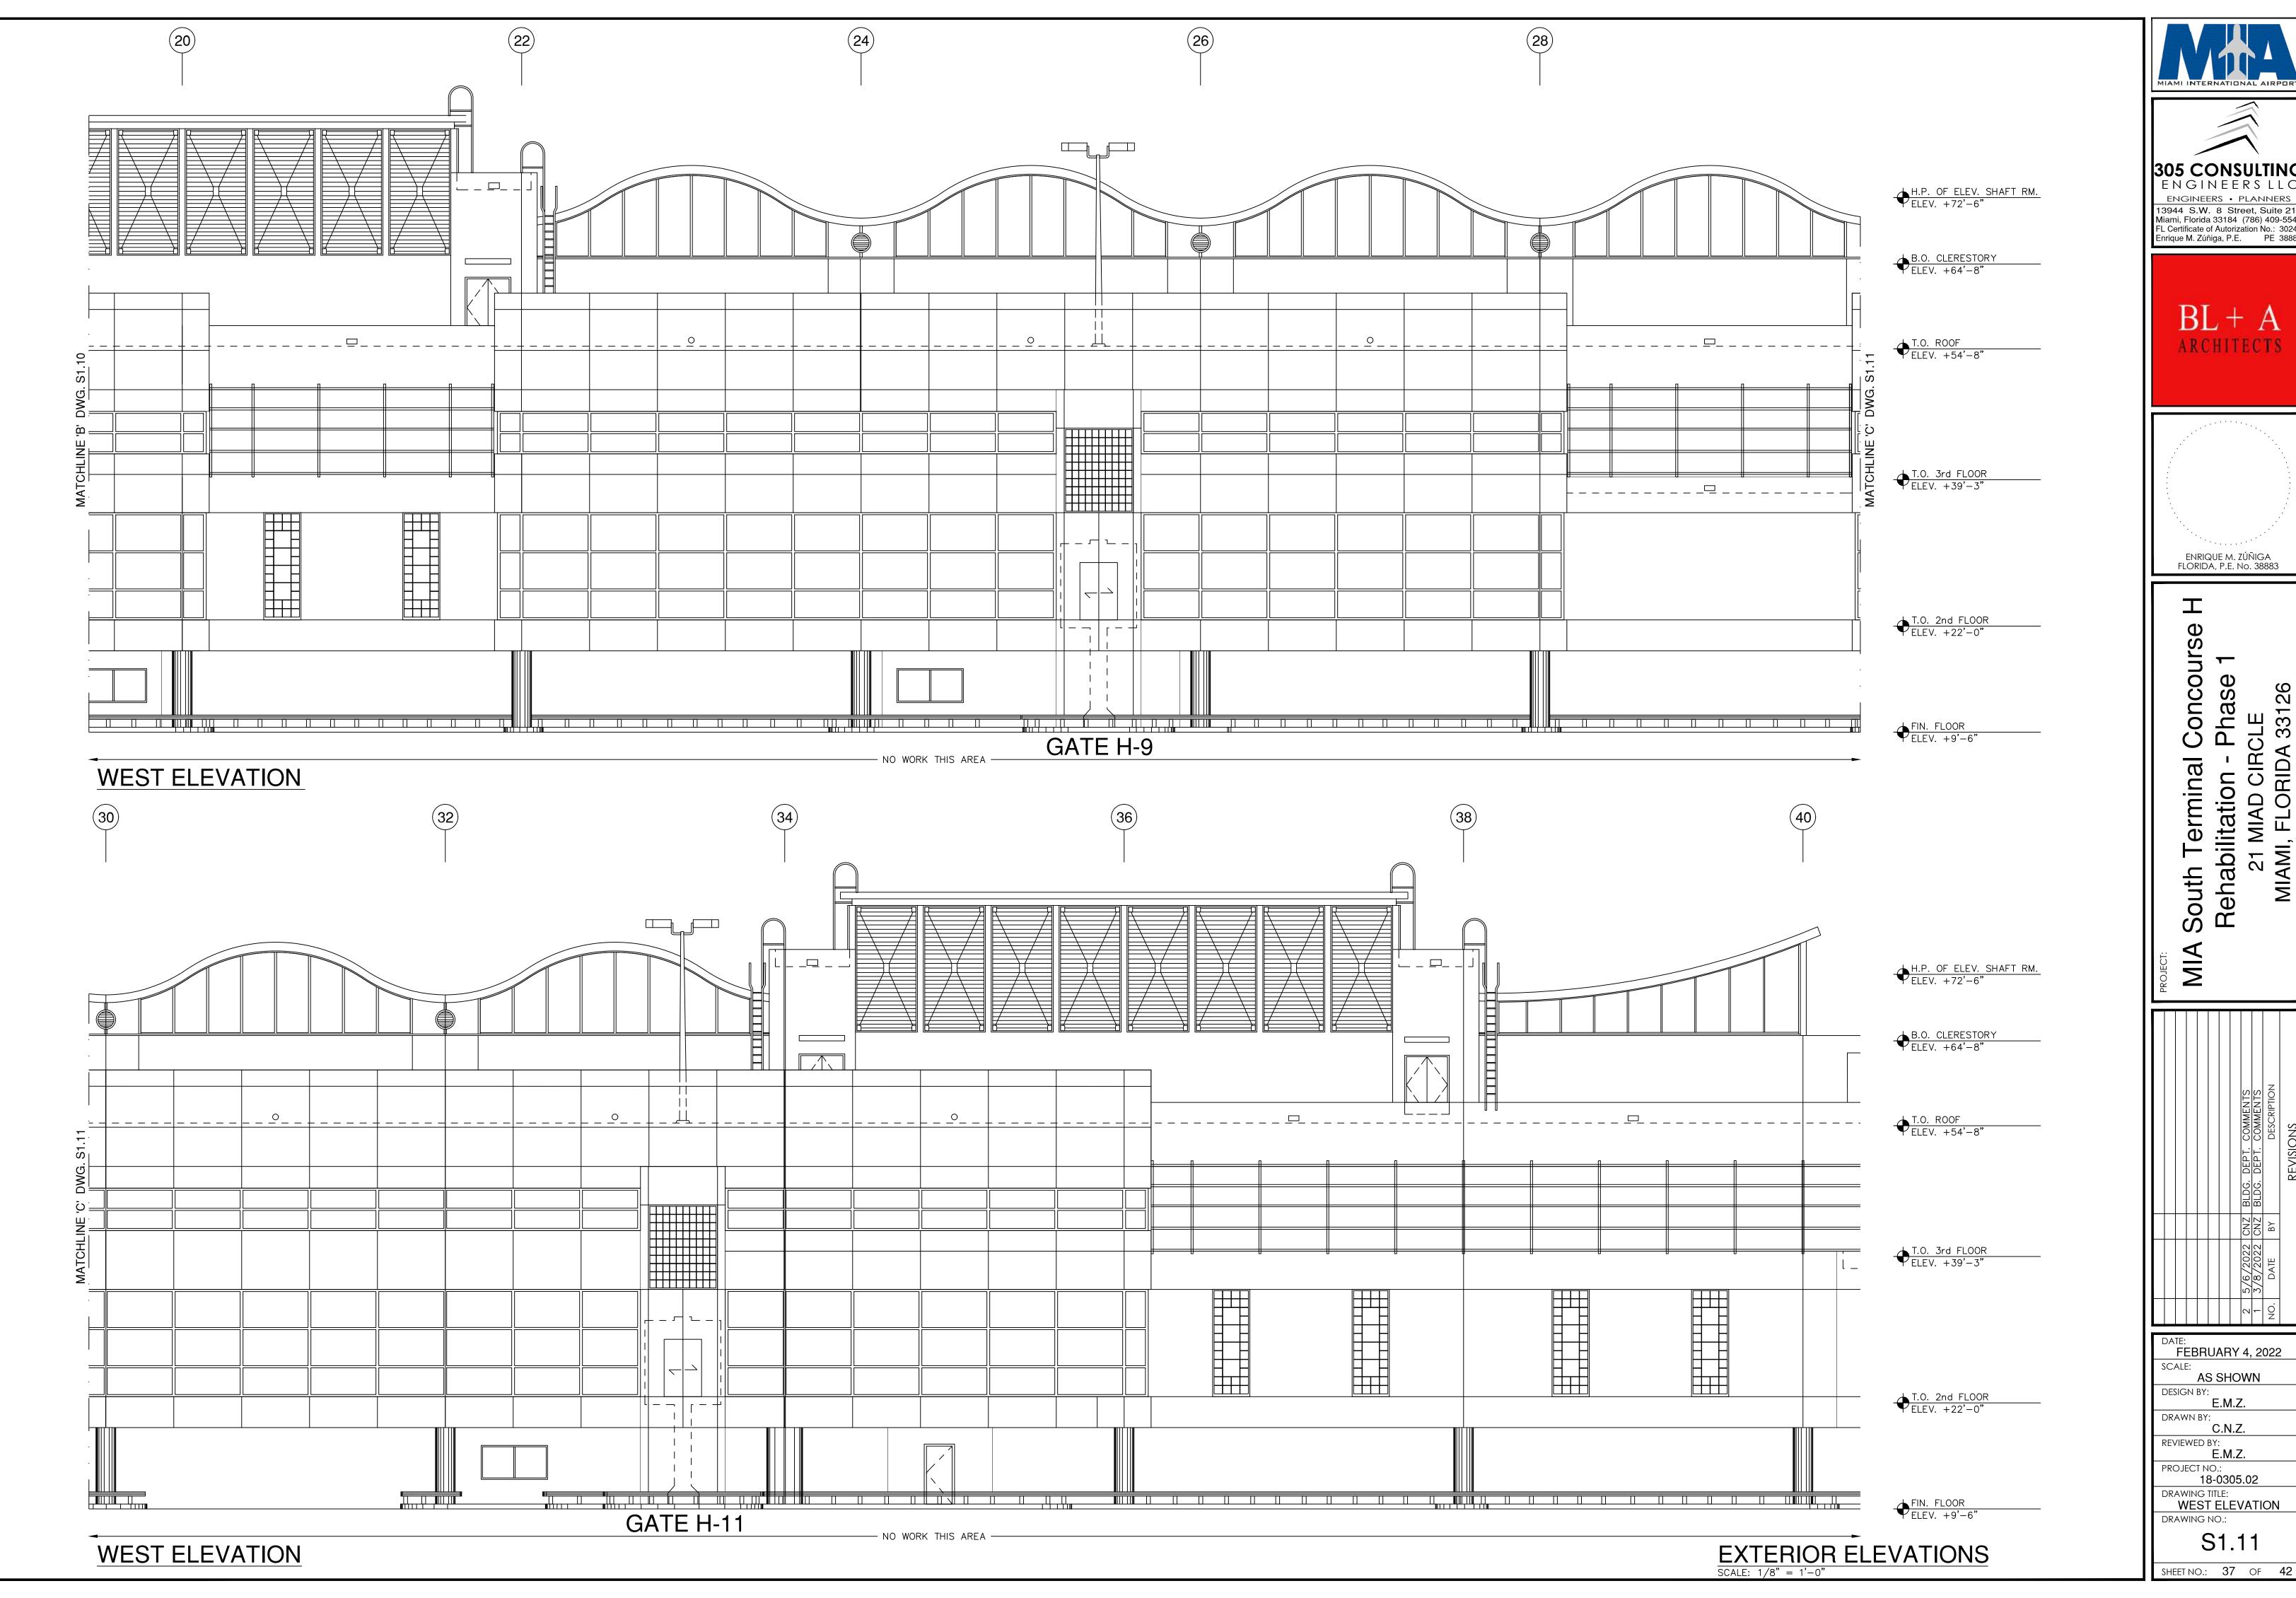
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PLOT DATE: 11/8/2023





#### WATER FILLED LOW-PROFILE BARRICADE N.T.S.

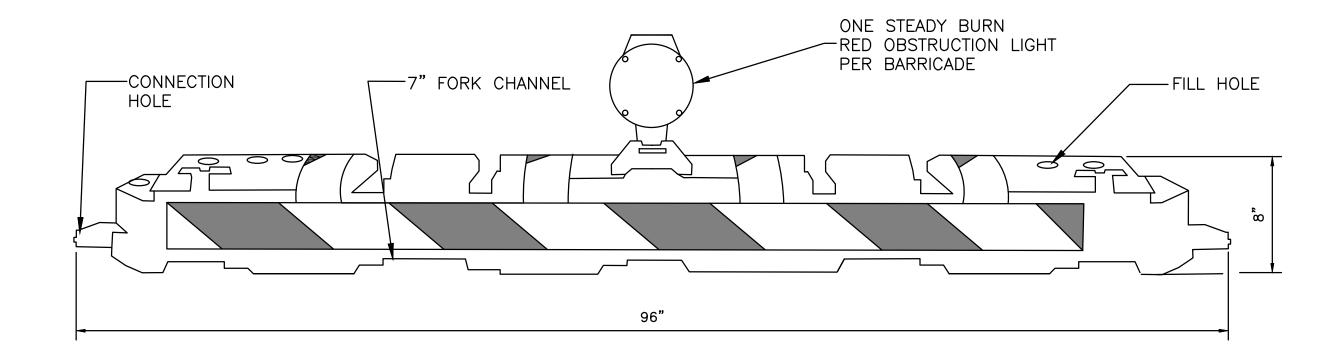
#### NOTES:

- 1. BARRICADES WITH STEADY BURNING RED LIGHTS LOCATED OVER PAVED AREAS TO BE PLACED AT 10' MAX. ON CENTER.
- 2. ALL BARRICADES SHALL BE MOVED AT LEAST ONCE A WEEK AND THE CONTRACTOR SHALL SWEEP THE DEBRIS THAT HAS ACCUMULATED AND REMOVE THIS DEBRIS FROM SITE. THE BARRICADES SHALL THEN BE REPLACED AT THE APPROPRIATE LOCATION.
- 3. ALL BARRICADE LIGHTING SHALL BE VERIFIED BY THE CONTRACTOR FOR PROPER OPERATION AT THE BEGINNING AND END OF EACH DAY BEFORE CONTRACTOR BEGINS AND CEASES OPERATION.
- 4. THESE BARRICADES TO BE USED WITHIN THE PROJECT MOT IN ORDER TO ENSURE EACH CONTRACTOR CONTAINS AND SAFES-UP THEIR WORK.
- 5. BARRICADES SHALL BE FILLED WITH WATER OR SAND TO PREVENT MOVEMENT FROM JET BLAST.





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A South Terminal Concourse F Rehabilitation - Phase 1 21 MIAD CIRCLE MIAMI, FLORIDA 33126

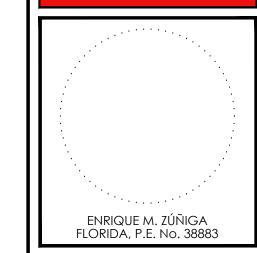			5/6/2022 CNZ BLDG. DEPT. COMMENTS	3/8/2022   CNZ   BLDG. DEPT. COMMENTS	DESCRIPTION	REVISIONS
			CNZ	CNZ	ВУ	
			5/6/2022	3/8/2022	DATE	
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DATE: FEBRUARY 4, 2022 SCALE: AS SHOWN DRAWN BY:

REVIEWED BY: E.M.Z. PROJECT NO.:

18-0305.02

DRAWING TITLE:

MOT TYPICAL DETAILS

DRAWING NO.:

MOT1.03

